
CONSTRUCTION/RECORD DRAWINGS

DOWNTOWN IRRP-2016

SW 1/4, SEC. 31, T.36N., R.5W., B.M. SE 1/4, SEC. 36, T.36N., R.6W., B.M.

CITY OF LEWISTON, NEZ PERCE COUNTY, IDAHO

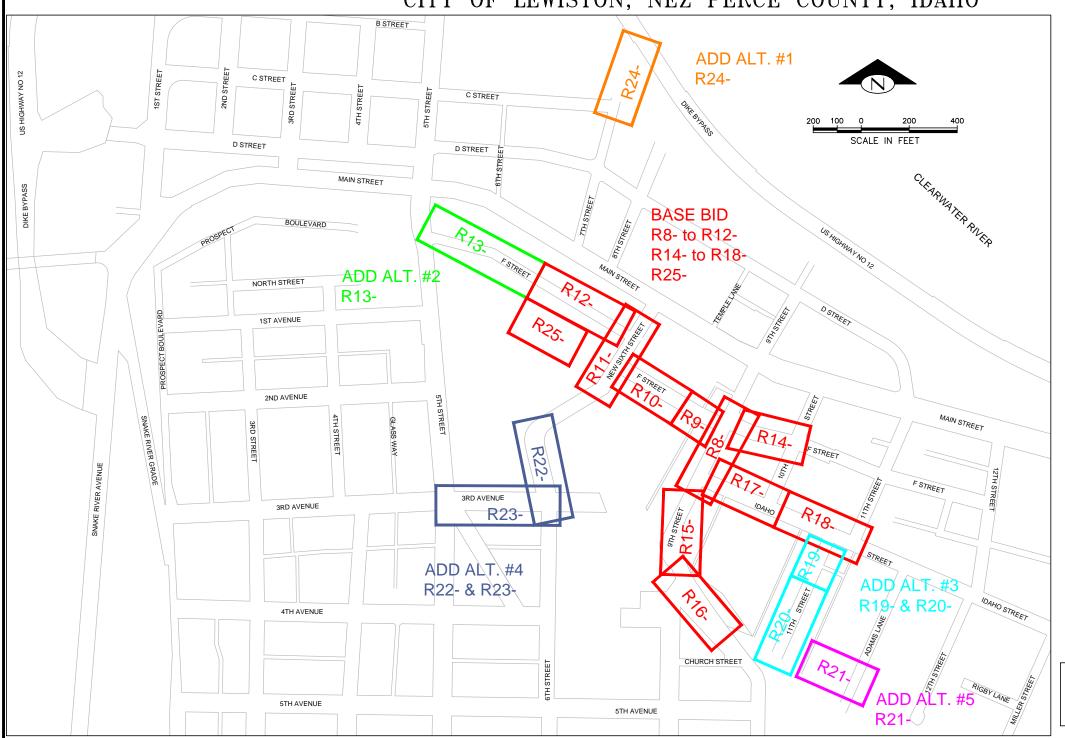

(BID DOCUMENTS)

SHEET INDEX

GENERAL

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G-2	LEGEND & SHEET LIST TABLE
G-3	GENERAL CONSTRUCTION NOTES
G-4	SURVEY CONTROL
G-5	STORM DRAIN STRUCTURE INDEX
G-6	QUANTITY SUMMARY SHEET
G-7	QUANTITY SUMMARY SHEET

PHASING

P-1	CONSTR	U(CTION PH	ASING	DIAGRAM
P-2	PHASE	1	TRAFFIC	FLOW	DIAGRAM
P-3	PHASE	2	TRAFFIC	FLOW	DIAGRAM
P-4	PHASE	3	TRAFFIC	FLOW	DIAGRAM
P-5	PHASE	4	TRAFFIC	FLOW	DIAGRAM
P-6	WATERLI	INE	E PHASIN	G DIAC	GRAM

ROADWAY

NOTE: NOT ALL SERIES CONTAIN ALL SHEETS (SEE SHEET G-2)

R8-A TO R25-A	REMOVAL PLANS WATER LINE PLAN AND PROFILES
	STORM DRAIN PLAN AND PROFILES - FEMA
R14-C,F TO R23-C,F	STORM DRAIN / STREET PLAN AND PROFILES- FEMA
	STORM DRAIN LATERAL PROFILES - FEMA
R8-E TO R13-E	SANITARY SEWER POINT REPAIR PLAN
R8-F TO R13-F	STREET IMPROVEMENT PLANS
R24-	7TH STREET BORING PLAN AND PROFILE — FEMA
R25-	F STREET PARKING LOT PLAN
S-1 & S-2	FRANCHISE UTILITY PLANS

DETAILS

B-1	DETAILS (WATER)
C-1	DETAILS (STORM) - FEM
□ 1	DETAILS (CANITADY)

F-1 DETAILS (SANITARY)
F-1 TO F-3 TYPICAL SECTIONS & DETAILS (STREETS)
F-4 TO F-6 INTERSECTION DETAILS (STREETS)


TRAFFIC 1 CRITICAL ACCESS PLAN

AGENCY TELEPHONE NUMBERS

CITY OF LEWISTON	PUBLIC	WORKS	DEPARTMEN'	T 746-3671,	ext.	252
AVISTA UTILITIES				798-1473		
CABLEONE				746-3325		
CENTURYLINK				798-8380		
PORT OF LEWISTON	١			743-5531		
DIGLINE UNDERGRO	UND UTI	LITY LO	CATE	811		



THE LOCATION OF EXISTING UTILITIES ON THESE PLANS ARE APPROXIMATE AND ARE SHOWN FOR INFORMATION ONLY. THE CONTRACTOR SHALL PERFORM A SEPARATE INVESTIGATION IN THE FIELD TO DETERMINE THE EXACT LOCATION OF ALL EXIST ING UNDERFORDIND UTILITIES. INFORMATION REGARDING THE LOCATION OF EXISTING UNDERSROUND UTILITIES CAN BE OBTAINED FORM CALLING DIG LINE AT 811.

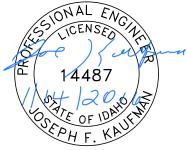

BID DOCUMENTS

SCALE WARNING HORIZONTAL AS SHOWN THIS BAR MEASURES							
HORIZONTAL O 1/2 1 AS SHOWN THIS BAR MEASURES						SCALE	WARNING
AS SHOWN THIS BAR MEASURES						JUALL	WAI II III MA
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VEDTICAL 4 (0" ON 44" 47" OUEST						VERTICAL	
1/2 of 17 All of 22	NO	DATE	FILENIAME	DESCRIPTION	BY		
NO. DATE FILENAME DESCRIPTION BY NA 11" ON 22"x34" SHEET REVISIONS WHEN PLOTTED TO SCALE	NO.	DAIL			51	NA	


CITY OF LEWISTON
PUBLIC WORKS DEPARTMENT
ENGINEERING SERVICES
215 'D' STREET, LEWISTON,ID 83501
208-746-4316
FAX 208-746-5595



DOWNTOWN INFRASTRUCTURE REPAIR
AND REPLACEMENT PROJECT (IRRP-2016)

COVER AND SHEET INDEX

DESIGNED BY:	DATE:	PROJECT:		
J. KAUFMAN	2015	IRRF	P-201	6
DRAWN BY:	DATE:	SHEET		
B. STEWART	12-16-2015	1	OF	89
CHECKED BY:	DATE:	DRAWING:	\sim	4
S. STUBBERS	01-14-2016		G-	١.

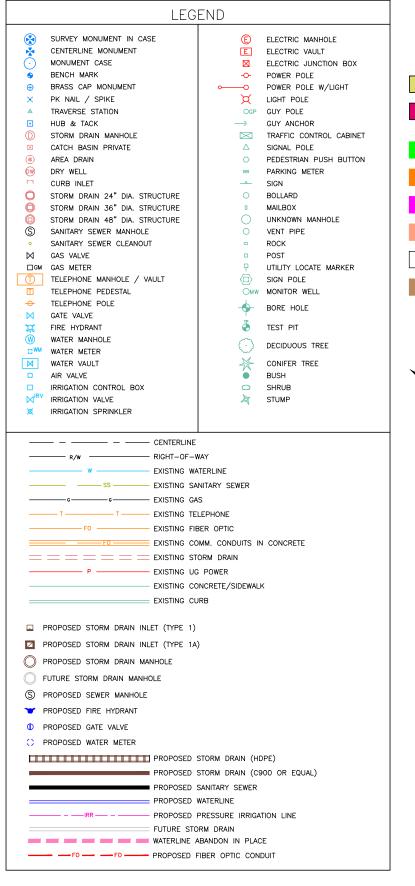

	PAVEMENT REMOVAL
	CONCRETE REMOVAL
	NEW LANDSCAPING
	NEW MISCELLANEOUS CONCRETE
4" 6"	NEW PEDESTRIAN RAMP
	NEW APPROACH
	NEW PAVEMENT
4" 6"	NEW CONCRETE
82 (94)	PROJECT PAY ITEM CALLOUT
$\stackrel{K}{\longrightarrow} \stackrel{M}{\longleftrightarrow}$	SPECIAL NOTE CALLOUT

Sheet List Table					
Sheet Number	Sheet Title	Sheet Description			
1	G-1	COVER AND SHEET INDEX			
2	G-2	LEGEND & SHEET LIST TABLE			
3	G-3	GENERAL CONSTRUCTION NOTES			
4	G-4	SURVEY CONTROL			
5	G-5	STORM DRAIN STRUCTURE INDEX			
6	G-6	QUANTITY SUMMARY SHEET			
7	G-7	QUANTITY SUMMARY SHEET			
8	P-1	CONSTRUCTION PHASING DIAGRAM			
9	P-2	TRAFFIC FLOW DIAGRAM PHASE 1			
10	P-3	TRAFFIC FLOW DIAGRAM PHASE 2			
11	P-4	TRAFFIC FLOW DIAGRAM PHASE 3			
12	P-5	TRAFFIC FLOW DIAGRAM PHASE 4			
13	P-6	WATERLINE PHASING DIAGRAM			
14	R8-A	REMOVAL PLAN			
15	R8-B	WATER LINE PLAN & PROFILE			
16	R8-C	STORM DRAIN PLAN & PROFILE			
17	R8-D	STORM DRAIN LATERAL PROFILES			
18	R8-F	STREET IMPROVEMENT PLAN			
19	R9-A	REMOVAL PLAN			
20	R9-B	WATER LINE PLAN & PROFILE			
21	R9-C	STORM DRAIN PLAN & PROFILE			
22	R9-D	STORM DRAIN LATERAL PROFILES			
23	R9-F	STREET IMPROVEMENT PLAN			
24	R10-A	REMOVAL PLAN			
25	R10-B	WATER LINE PLAN & PROFILE			
26	R10-C	STORM DRAIN PLAN & PROFILE			
27	R10-E	SANITARY SEWER POINT REPAIR PLAN			
28	R10-F	STREET IMPROVEMENT PLAN			
29	R11-A	REMOVAL PLAN			
30	R11-B	WATER LINE PLAN & PROFILE			
31	R11-C	STORM DRAIN PLAN & PROFILE			
32	R11-D	STORM DRAIN LATERAL PROFILES			
33	R11-E	SANITARY SEWER POINT REPAIR PLAN			
34	R11-F	STREET IMPROVEMENT PLAN			
35	R12-A	REMOVAL PLAN			
36	R12-B	WATER LINE PLAN & PROFILE			
37	R12-C	STORM DRAIN PLAN & PROFILE			
38	R12-D	STORM DRAIN LATERAL PROFILES			
39	R12-E	SANITARY SEWER POINT REPAIR PLAN			
40	R12-F	STREET IMPROVEMENT PLAN			
41	R13-A	REMOVAL PLAN			
42	R13-B	WATER LINE PLAN & PROFILE			
43	R13-C	STORM DRAIN PLAN & PROFILE			
44	R13-E	SANITARY SEWER POINT REPAIR PLAN			
45	R13-F	STREET IMPROVEMENT PLAN			

	Sheet List Table					
Sheet Number	Sheet Title	Sheet Description				
46	R14-A	REMOVAL PLAN				
47	R14-C,F	STORM DRAIN / STREET PLAN & PROFILE				
48	R15-A	REMOVAL PLAN				
49	R15-C,F	STORM DRAIN / STREET PLAN & PROFILE				
50	R15-D	STORM DRAIN LATERAL PROFILES				
51	R16-A	REMOVAL PLAN				
52	R16-C,F	STORM DRAIN / STREET PLAN & PROFILE				
53	R16-D	STORM DRAIN LATERAL PROFILES				
54	R17-A	REMOVAL PLAN				
55	R17-C,F	STORM DRAIN / STREET PLAN & PROFILE				
56	R17-D	STORM DRAIN LATERAL PROFILES				
57	R18-A	REMOVAL PLAN				
58	R18-C,F	STORM DRAIN / STREET PLAN & PROFILE				
59	R18-D	STORM DRAIN LATERAL PROFILES				
60	R19-A	REMOVAL PLAN				
61	R19-C,F	STORM DRAIN / STREET PLAN & PROFILE				
62	R19-D	STORM DRAIN LATERAL PROFILES				
63	R20-A	REMOVAL PLAN				
64	R20-C,F	STORM DRAIN / STREET PLAN & PROFILE				
65	R20-D	STORM DRAIN LATERAL PROFILES				
66	R21-A	REMOVAL PLAN				
67	R21-C,F	STORM DRAIN / STREET PLAN & PROFILE				
68	R22-A	REMOVAL PLAN				
69	R22-C	STORM DRAIN PLAN & PROFILE				
70	R22-D	STORM DRAIN LATERAL PROFILES				
71	R22-F	STREET IMPROVEMENT PLAN				
72	R23-A	REMOVAL PLAN				
73	R23-C,F	STORM DRAIN / STREET PLAN & PROFILE				
74	R24-A	REMOVAL PLAN				
75	R24-C,F	STORM DRAIN / STREET PLAN & PROFILE				
76	R25-A	F STREET PARKING REMOVAL PLAN				
77	R25-F	F STREET PARKING IMPROVEMENT PLAN				
78	S-1	FRANCHISE UTILITY PLAN				
79	S-2	FRANCHISE UTILITY PLAN				
80	B-1	DETAILS WATER				
81	C-1	DETAILS STORM DRAIN				
82	E-1	DETAILS SANITARY SEWER				
83	F-1	TYPICAL SECTIONS & DETAILS (STREET)				
84	F-2	TYPICAL SECTIONS & DETAILS (STREET)				
85	F-3	TYPICAL SECTIONS & DETAILS (STREET)				
86	F-4	INTERSECTION DETAILS				
87	F-5	INTERSECTION DETAILS				
88	F-6	INTERSECTION DETAILS				
89	T-1	CRITICAL ACCESS PLAN				



BID DOCUMENTS

					SCALE	WARNING
					HORIZONTAL NA	0 1/2 1
NO.	DATE	FILENAME	DESCRIPTION	BY	VERTICAL NA	THIS BAR MEASURES 1/2" ON 11"x17" SHEET 1" ON 22"x34" SHEET WHEN PLOTTED TO SCALE
			REVISIONS			WHEN FEOTIED TO SCALE

CITY OF LEWISTON
PUBLIC WORKS DEPARTMENT
ENGINEERING SERVICES
215 'D' STREET, LEWISTON, ID 83501
208-748-1316
FAX 208-746-5595



DC	OWNTOWN	INFRA	STRUCTUI	RE REPAIR
AND	REPLACE	MENT	PROJECT	(IRRP-2016)

LEGEND	&	SHEET	LIST	TABLE	
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	212 200	- III
DESIGNED BY:	DATE:	PROJECT:
J. KAUFMAN	2015	IRRP-2016
DRAWN BY:	DATE:	SHEET
B. STEWART	12-16-2015	2 _{OF} 89
CHECKED BY:	DATE:	DRAWING: O
S. STUBBERS	01-14-2016	G-2

GENERAL CONSTRUCTION

- 1. All construction work shall conform to the City of Lewiston Standards and Specifications and the 2015 version of the Idaho Standards for Public Works Construction (ISPWC). In the case of conflict, the Project Plans and Technical Specifications will prevail over City Standards which will prevail over ISPWC.
- 2. The Contractor and Utility Contractors shall attend a pre-construction conference (and on-site meeting with the City of Lewiston Public Works Supervisor) prior to start of work. The Contractor shall conduct a weekly project meeting with the Engineer and City.
- 3. Contractors shall notify the appropriate agency when materials are on site or inspection of the work is required. No work may begin on any project without Twenty Four (24) hours prior notice.
- 4. Work subject to approval by any governmental agency must be approved prior to (A) backfilling trenches for pipe: (B) placing of aggregate base: (C) placing of concrete: (D) placing of asphalt paving. All newly installed stormwater and wastewater lines shall be videoed per Lewiston Public Works Policy #2012-2 prior to paving and prior to final payment.
- 5. Inspection, approval and final acceptance of all construction shall be by the Public Works Department, and their decision shall be final. Such inspection shall not relieve the contractor from the responsibility of performing the work in an acceptable manner and in accordance with the DEQ approved construction plans.
- 6. Any deviation from the approved plans and specifications must have the applicable agency approval in writing prior to construction
- 7. The Contractor shall promptly remove from the vicinity of the completed work, all rubbish, mud in streets, removed materials, all excess materials, construction equipment, temporary structures, and facilities used during construction. Final acceptance and final payment will be withheld until the Contractor has satisfactorily cleaned the site, including staging and waste areas as determined by Public Works Department.
- 8. Contractor shall maintain critical access points as shown in the plans. Properties with water and sewer services impacted by construction activities shall be notified of construction activities by the Contractor a minimum of 2 working days prior to disturbing their service(s).
- 9. Contractors shall be responsible for coordinating with affected franchise utilities during construction.
- 10. Contractor is likely to encounter abandoned pipes, utilities, or other miscellaneous items during excavation; they are to be removed, incidental to related items unless otherwise listed in the plans.
- 11. Weekly Progress meetings must be attended by the Contractor's supervisor with change order decision authority.
- 12. The City of Lewiston will provide construction staking as stated in the contract documents.

TRAFFIC CONTROL

- 1. Contractor shall be responsible to provide traffic control plans for each phase of construction as shown on the "construction phasing diagram", Drawing P-1 and the traffic flow diagrams on Drawings P-2 thru P-5. These plans shall include consideration of pedestrian traffic, both to business entrances and along sidewalks.
- 2. The traffic control plan for each phase of construction (see "construction phasing diagram", Drawing P-1) shall be submitted to the Engineer at least ten working days before construction, and must be approved by the Engineer prior to beginning work.
- 3. All traffic control items shall be included in bid item 1103.4.1.b.1 construction traffic control.
- 4. Traffic control items and signs required to accommodate the specific construction situation, shall be included in the bid price. Signs, flaggers, channelization devices and other traffic control items shall be in accordance with the current Manual on Uniform Traffic Control Devices (MUTCD 2009) as adopted and modified by the state of Idaho.
- 5. Special events in the project area that require specific planning, traffic control, and access are listed in CN-040 of the Special Provisions. These include Main Street parades and car shows.
- 6. Place channelization devices (cones, barrels, etc.) On the outside lane edge adjacent to the excavation area in accordance with the MUTCD. Place applicable signs (shoulder drop off, etc.) And warning devices as conditions warrant during construction.
- 7. All traffic control plans shall be submitted on an aerial photo and shall be drawn to scale.
- 8. Minimum allowable traffic lane width shall be 10 ft.

ROADWAY

- 1. All Contractors working within the public road right-of-way are required to secure a right-of-way construction permit from the City of Lewiston at least twenty four (24) hours prior to any construction. The City will pay the ROW fee for this project.
- 2. The City of Lewiston will inspect all work within the public rights-of-way to include utility trenches above the pipe zone. The City will inspect all connections to existing infrastructure (water, sewer, and storm drain).
- 3. It shall be the Contractor's responsibility to coordinate changes to traffic and pedestrian lights with the City of Lewiston Street Maintenance Division.
- 5. All asphalt and concrete joints shall be saw cut unless specifically noted otherwise in the drawings.
- 6. Final and temporary striping of newly paved streets will be the responsibility of the City of Lewiston.

PUBLIC SURVEY MONUMENT

1. All found public and private survey monuments including centerline monuments, section corners, property pins and reference monuments in the project area are to be shown on the construction plans, referenced before they are disturbed by construction, and reestablished prior to project completion per Idaho Code Title 55, Chapter 16. All public and private land survey monuments that will be disturbed by construction activities must be referenced by an Idaho licensed professional land surveyor prior to disturbance. All disturbed public and private monuments shall be reestablished by an Idaho licensed professional land surveyor before project completion. If monuments are found during construction that are not shown on the construction plans, the monuments must be referenced and reestablished by an Idaho licensed professional land surveyor. Section corner monuments disturbed and reestablished after construction shall have corner records completed and recorded at the Nez Perce County Recorder's office.

WATER / SEWER

- 1. Construction of potable water lines shall conform to the standards in the "Idaho Rules for Public Drinking Water Systems (IDAPA 58.01.08)" as well as ISPWC 2015. Properties shall be notified as outlined in General Construction Note No. 1.
- 2. The horizontal separation of potable water mains and non-potable water mains (sanitary sewer, storm drain, and irrigation) shall be a minimum of ten (10) feet. Where it is necessary for potable water main and non-potable water main to cross with less than eighteen (18) inches of vertical separation, the crossing shall be constructed in accordance with Section 542.07 of the Idaho Rules for Public Drinking Water Systems (IDAPA 58.01.08) and Section 430.02 of the Wastewater Rules (IDAPA 58.01.16).
- 3. The Contractor shall be responsible for notifying existing water users prior to disrupting service in accordance with General Construction Note No. 8. No user shall be without water or sewer service overnight. No user shall be without water and sewer for more than 4 hours during normal business hours.
- 4. All water works components shall be ANSI/NSF 61 Certified, and must meet all American Water Works Association (AWWA) and standard requirements of the Idaho Rules for Public Drinking Water Systems (IDAPA 58.01.08).
- 5. The design, construction, installation, maintenance and materials to complete a temporary dewatering system to provide adequate dewatering during construction will not be measured and paid for separately but included in the project.
- 6. All utility crossings shown on the plans are incidental to the project unless otherwise noted with a specific pay item.
- 7. All sewer service laterals shown are drawn from the observed connection point at a 2 percent slope and 90 degree horizontal angle from the sewer line. Actual depth and alignments may vary
- 8. Utility locations shown are approximate. Contractor shall verify exact locations in field prior to excavation. Any utilities damaged during construction shall be repaired by the contractor or utility company, at the contractor's expense, to the satisfaction of the utility company. Contractors shall be responsible to contact the local one-call system at 811 at least two days prior to any digging.
- 9. The new water main shall be constructed in accordance with these plans and the City of Lewiston Standard Drawings. All work shall also be in accordance with the specifications of the Idaho Standards for Public Works Construction. All work shall be subject to acceptance by the City of Lewiston pursuant to the engineering department's current inspection checklist.
- 10. The new water main shall be constructed in the sequence indicated by the phasing plan, unless otherwise approved.
- 11. Thrust blocks shall be installed at all fitting locations specified by City Standard Drawing 4-4. Thrust blocks shall be constructed to sizes based on allowable soil stress of 2000 psi. All mechanical joints 10" and smaller shall be equipped with ring-type grip restraint devices.
- 12. The Contractor shall pressure test the new water main in accordance with the phasing plan and AWWA C600.
- 13. Disinfection shall be by the City according to the phasing plan Drawing P-6.
- 14. Brian Hall the City's Water Distribution Supervisor (208-791-2032) shall be contacted 2 business days prior to any pressure testing/disinfection of the public main. The disinfection procedures can only be scheduled on Monday, Tuesday or Wednesday. He shall also be contacted 2 business days prior to any tie in. Tie ins can occur on any weekday but must occur before noon on Friday. Any alterations to these notifications or work schedules must be approved by the engineer. The City reserves the right to bill the Contractor for overtime for if work is requested to be afterhours or on weekends.
- 15. Connection to existing mains shall be in the presence of City Water Dept. personnel.

STORM SEWER

- 1. Catch basins and manholes shall be constructed per City of Lewiston, Idaho, Public Works Department Standards. See drawing 6-1 through 6-12 for drawing details. Stormwater Type 1 Catch Basin, Std. Dwg 6-8 shall be provided at all locations where pipe sizes permit. Stormwater Type 1a Catch Basin, Std. Dwg 6-9 shall be provided at all locations where larger pipe sizes require their use. All catch basins shall have curb openings unless located within a driveway. Curb openings may be eliminated only in special circumstances and only as approved by the Engineer. Where inlet locations have moved along the curb from the existing location to a new location, the flow line of the gutter or asphalt shall be formed to ensure positive drainage to the new inlet location. Field verification that gutter flow can be achieved shall be performed by the contractor prior to the installation of the inlet.
- 2. Removal of existing storm drain and pipe within the project limits shall be incidental to the new pipe being installed in the same or nearby location. The City will retain ownership of all removed frames, grates, and lids. Contractor shall stockpile removed items in a location designated by the City. Pipes, catch basins, inlets and manholes that shall be removed or abandoned are as shown on the removal plan. Pipes to be abandoned shall be plugged at the disconnected end with a concrete plug. Manholes deeper than 4 feet may be abandoned by removing the top 4 feet of the manhole riser and backfilling with 3/4" aggregate or flowable fill. Compaction within and above the abandoned manhole is required.
- 3. Manhole lids shall be rotated on the underlying structure so they are out of wheel paths.
- 4. Several locations are called out in the plans to connect existing storm drain components to new storm drain components. Work and materials for these connections shall be considered incidental to the new storm drain components unless specifically stated. Industry standard connections shall be used. When coring and grooving is required, a non-shrinking grout shall be used.
- 5. All utility crossings shown on the plans are incidental to the project unless otherwise noted with a specific pay item.
- 6. Contractor to maintain and preserve construction site drainage. Damage caused by weather will be the responsibility of the contractor. Cleanup and repair will be at the contractor's expense. The Contractor shall be advised that the adjacent buildings to the Project area have old basements that make them susceptible to leaking and flooding when the adjacent sidewalk, curb, or street surfaces are removed and that it is in the best interest of City and the Contractor to maintain a stormwater drainage system that is capable of handling infrequent storm events throughout construction. It is the sole responsibility of the Contractor to prosecute the Work in a manner that protects private property and the Project area from flooding due to high intensity storm events. The City will not pay additional costs associated with the damage to the Project area or private property resulting from stormwater runoff. Time spent preparing for a forecast storm, whether it rains in the project area or not, will be interpreted in the same manner for the purposes of adding contract days due to weather.
- 7. Catch basins and manholes shall have the pipes completely grouted on the interior and exterior prior to active use for stormwater conveyance.
- 8. Storm drain pipes shall not be grouted until the temperature of the new pipes has equalized to adjacent structures. Grout gaps due to thermal contraction of storm pipes shall be fixed at the Contractor's expense prior to payment.



BID DOCUMENTS


CITY OF LEWISTON
PUBLIC WORKS DEPARTMENT
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215 'D' STREET, LEWISTON, ID 83501
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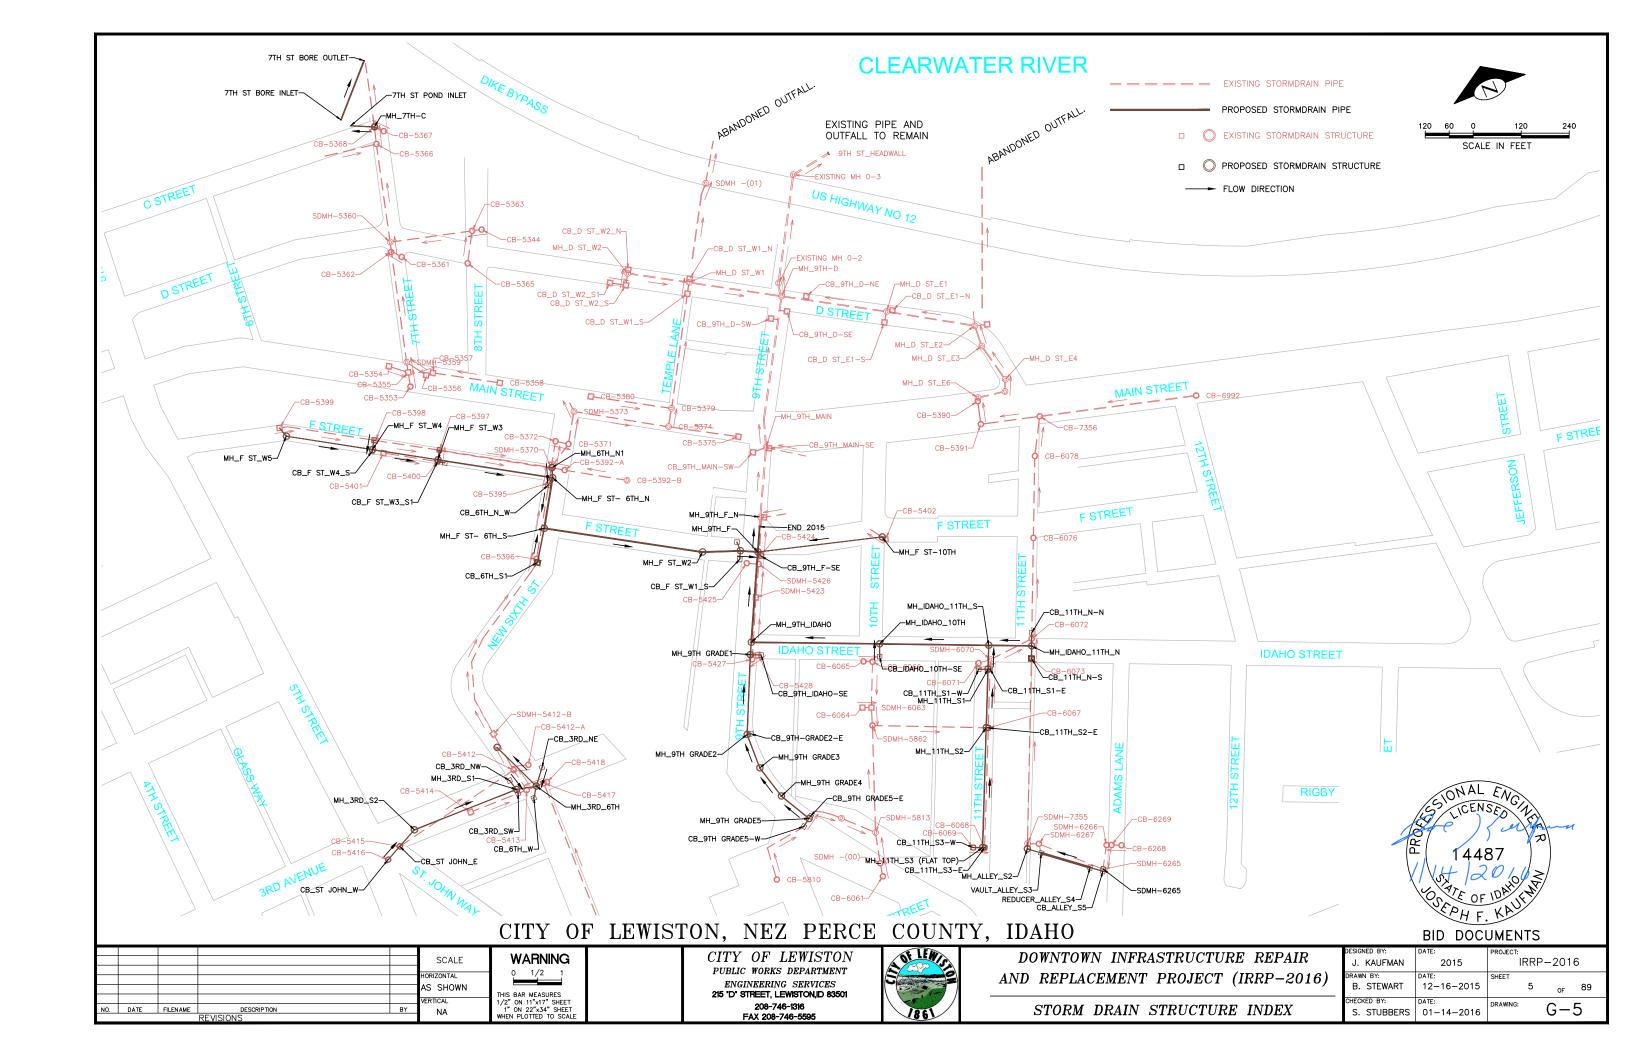


DOWNTOWN INFRASTRUCTURE REPAIR AND REPLACEMENT PROJECT (IRRP-2016)

GENERAL CONSTRUCTION NOTES

DESIGNED BY:	DATE:	PROJECT:				
J. KAUFMAN	2015	IRRP-2016				
DRAWN BY: B. STEWART	DATE: 12-16-2015	SHEET 3 OF 8	39			
CHECKED BY: S. STUBBERS	DATE: 01-14-2016	DRAWING: G-3				



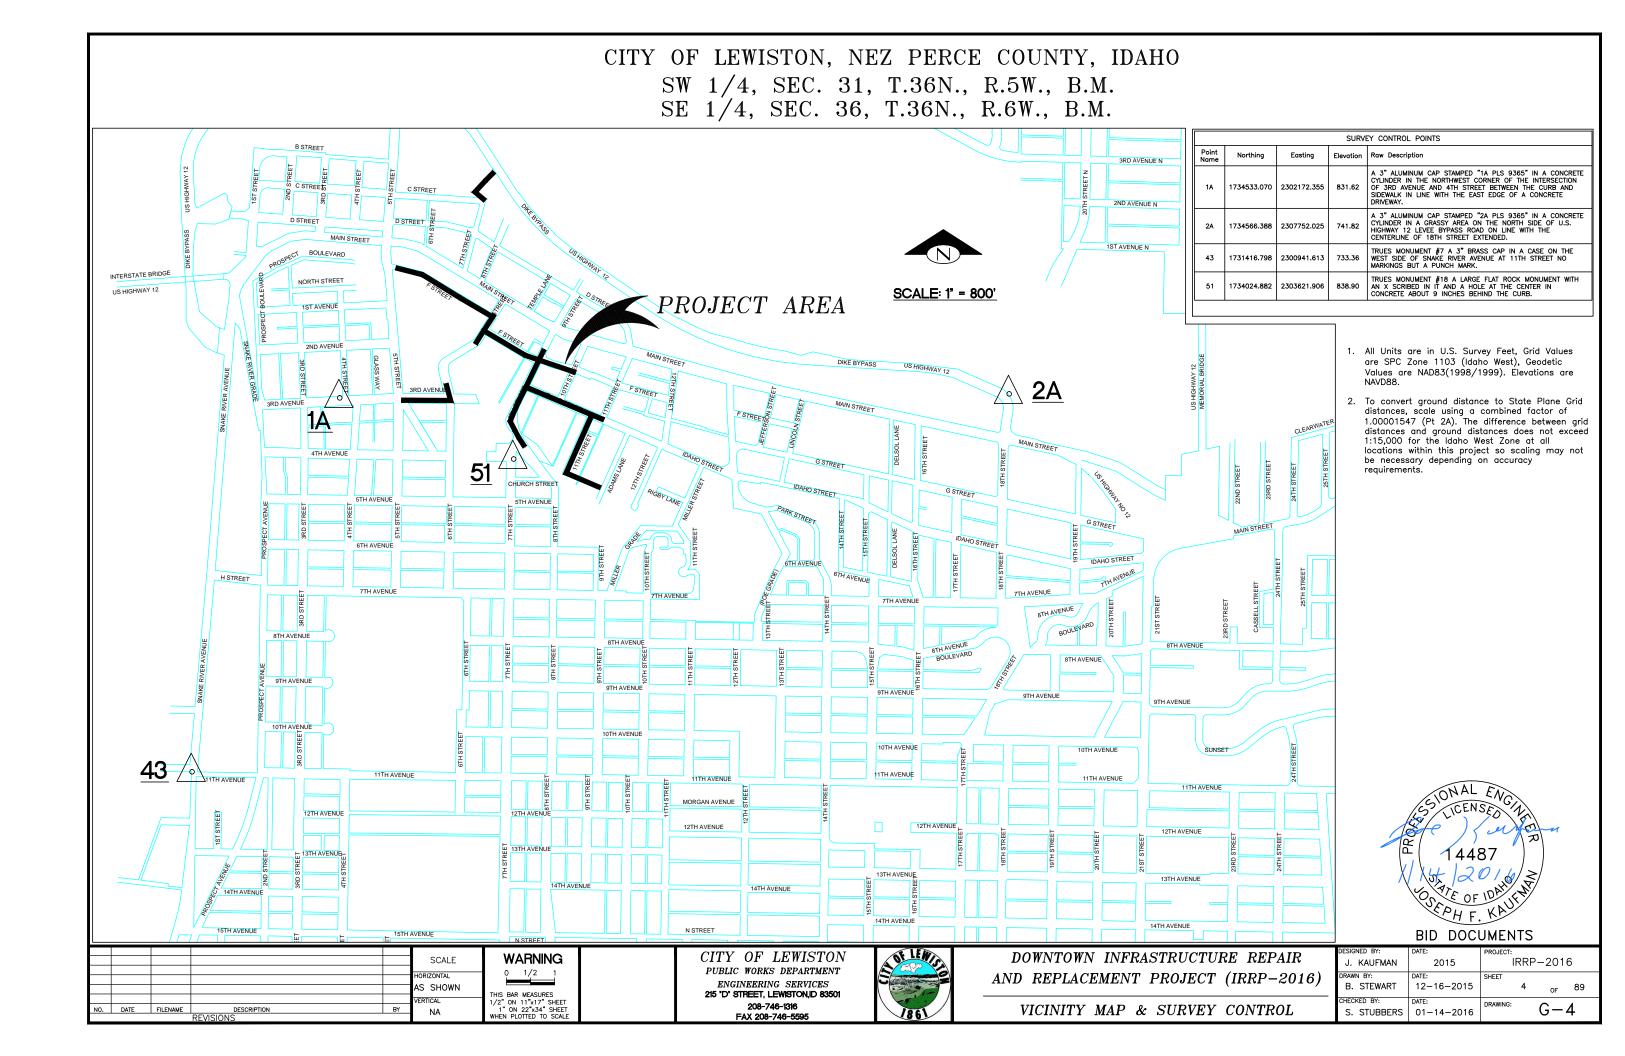

DOWNTOWN IRRP 2016 BASE BID

CITY OF LEWISTON

Item	Bid Item	Description of Item			Es	timate
No.	No.		Unit	Quantity	Price	Amount
Divisi	on 200 - Earthw	ork				
95	201.4.1.G.1	Removal of Obstructions	CY	30		
96	201.4.1.H.1	Removal of Obstructions	LF	500		
1	201.4.1.C.1	Removal of Obstructions	EA	15		
2	201.4.1.D.1A	Removal of Sidewalk	SY	1,157		
3	201.4.1.D.1B	Removal of Bituminous Surface	SY	7,324		
4	201.4.1.E.1	Removal of Curb	LF	2,008		
5	201.4.1.F.1	Removal of Manhole	EA	1		
6	201.4.1.F.2	Removal of Catch Basin	EA	17		
7	SP-201.A	Abandon Pipe In Place (Plug End)	EA	50		
8	SP-201.B	Abandon Pipe (Removal)	LF	40		
9	SP-201.C	Abandon Pipe In place (Grout Fill)	CY	8.5		
10	202.4.1.A.1	Excavation	CY	2,050		
11	201.4.1.D.1C	Removal of Concrete w/ Ashpalt overlay	SY	2,071		
Divisi	on 300 - Trench	in a				
	302.4.1.A.1	Rock Excavation	CY	10		
13	307.4.1.G.1	Main Line Type "P" Surface Restoration	SY	2308		
1.5	507.4.1.0.1	(Asphalt Roadway)	51	2500		
Divisi	on 400 - Water					
	401.4.1.A.1A	Water Main Pipe - Size 4" - DI - Class 350	LF	75		
16	401.4.1.A.1B	Water Main Pipe - Size 4 - DI - Class 350	LF	178		
17	401.4.1.A.1C	Water Main Pipe - Size 8" - DI - Class 350	LF	113		
18	401.4.1.A.1D	Water Main Pipe - Size 8 - DI - Class 350 Water Main Pipe - Size 10" - DI - Class 350	LF	1341		
19	401.4.1.B.1	Water Main Fitting - Size " - DI	EA	41		
20	401.4.1.B.1 401.4.1.C.1A	Connect to Existing Main - 4"	EA	41		
21	401.4.1.C.1A 401.4.1.C.1B	Connect to Existing Main - 4 Connect to Existing Main - 6"	EA	2		
22	401.4.1.C.1C	Connect to Existing Main - 8"	EA	2		
23	401.4.1.C.1D	_	EA	1		
24	401.4.1.C.1D	Connect to Existing Main - 10" Valve - Size 4"	EA	5		
				7		
25	402.4.1.A.1B	Valve - Size 6"	EA			
26	402.4.1.A.1C	Valve - Size 8"	EA	2		
27	402.4.1.A.1D	Valve - Size 10"	EA	9		
28	403.4.1.A.1	Hydrant	EA	4		
29	404.4.1.A.1	Water Service Connection, No Meter, Size,	EA	9		
30	404.4.1.B.1	Connect to Existing Service Pipe, Size", Item	EA	10		
31	SP-404A	Potable Water Main Crossing	EA	13		
32	SP-404B	Potable Water Lateral Crossing	EA	0		
33	404.4.1.C.1A	Water Service Pipe 3/4" or 1"	LF	349		
34	404.4.1.C.1B	Water Service Pipe 1 1/4" or 1 1/2"	LF	29		
35	404.4.1.C.1C	Water Service Pipe 2"	LF	90		
37	SP-404C	Remove Inactive Water Service	EA	25		
Divisi	on 500 – Sewer					
39	507.4.1.D.3	Install 8" Full Circle Repair Clamp	EA	6		
40	507.4.1.E.1A	Replace 4" Dia. Pipe	LF	36		
41	507.4.1.E.1B	Replace 8" Dia. Pipe	LF	130		
42	507.4.1.F.1	Repair Service Connection	EA	8		
Dinici	on 600 - Storm I	Omerine				
49		12" Storm Drain Pipe, Class C900, (PVC)	LF	91		
51		18" Storm Drain Pipe, Class C900, (PVC)	LF	20		
	601.4.1.A.17A	-	LF	505		
52		15" Storm Drain Pipe, Type S, (CPP)	LF	417		
52	601.4.1.A.17B					
53	601.4.1.A.17B 601.4.1.A.17C		LF	676		i e
53 54	601.4.1.A.17C	18" Storm Drain Pipe, Type S, (CPP)	LF LF	676 688		
53 54 55	601.4.1.A.17C 601.4.1.A.17D	18" Storm Drain Pipe, Type S, (CPP) 24" Storm Drain Pipe, Type S, (CPP)	LF	688		
53 54 55 56	601.4.1.A.17C 601.4.1.A.17D 601.4.1.A.17E	18" Storm Drain Pipe, Type S, (CPP) 24" Storm Drain Pipe, Type S, (CPP) 30" Storm Drain Pipe, Type S, (CPP)	LF LF	688 931		
53 54 55 56 57	601.4.1.A.17C 601.4.1.A.17D 601.4.1.A.17E 601.4.1.C.1	18" Storm Drain Pipe, Type S, (CPP) 24" Storm Drain Pipe, Type S, (CPP) 30" Storm Drain Pipe, Type S, (CPP) Existing Storm Drain Connection	LF LF EA	688 931 14		
53 54 55 56 57 58	601.4.1.A.17C 601.4.1.A.17D 601.4.1.A.17E 601.4.1.C.1 602.4.1.A.1A	18" Storm Drain Pipe, Type S, (CPP) 24" Storm Drain Pipe, Type S, (CPP) 30" Storm Drain Pipe, Type S, (CPP) Existing Storm Drain Connection Storm Drain Catch Manhole, 48" Diameter	LF LF EA EA	688 931 14 13		
53 54 55 56 57 58 59	601.4.1.A.17C 601.4.1.A.17D 601.4.1.A.17E 601.4.1.C.1 602.4.1.A.1A 602.4.1.A.1B	18" Storm Drain Pipe, Type S, (CPP) 24" Storm Drain Pipe, Type S, (CPP) 30" Storm Drain Pipe, Type S, (CPP) Existing Storm Drain Connection Storm Drain Catch Manhole, 48" Diameter Storm Drain Catch Manhole, 60" Diameter	LF LF EA EA	688 931 14 13 6		
53 54 55 56 57 58 59 61	601.4.1.A.17C 601.4.1.A.17D 601.4.1.A.17E 601.4.1.C.1 602.4.1.A.1A 602.4.1.A.1B 602.4.1.F.1A	18" Storm Drain Pipe, Type S, (CPP) 24" Storm Drain Pipe, Type S, (CPP) 30" Storm Drain Pipe, Type S, (CPP) Existing Storm Drain Connection Storm Drain Catch Manhole, 48" Diameter Storm Drain Catch Manhole, 60" Diameter Catch Basin - City of Lewiston Std (Type 1)	LF LF EA EA EA	688 931 14 13 6 15		
53 54 55 56 57 58 59	601.4.1.A.17C 601.4.1.A.17D 601.4.1.A.17E 601.4.1.C.1 602.4.1.A.1A 602.4.1.A.1B	18" Storm Drain Pipe, Type S, (CPP) 24" Storm Drain Pipe, Type S, (CPP) 30" Storm Drain Pipe, Type S, (CPP) Existing Storm Drain Connection Storm Drain Catch Manhole, 48" Diameter Storm Drain Catch Manhole, 60" Diameter	LF LF EA EA	688 931 14 13 6		
53 54 55 56 57 58 59 61 62 64	601.4.1.A.17C 601.4.1.A.17D 601.4.1.A.17E 601.4.1.C.1 602.4.1.A.1A 602.4.1.F.1A 602.4.1.F.1B 601.4.1.B.1B	18" Storm Drain Pipe, Type S, (CPP) 24" Storm Drain Pipe, Type S, (CPP) 30" Storm Drain Pipe, Type S, (CPP) Existing Storm Drain Connection Storm Drain Catch Manhole, 48" Diameter Storm Drain Catch Manhole, 60" Diameter Catch Basin - City of Lewiston Std (Type 1) Catch Basin - City of Lewiston Std (Type 1a) Inserta Tee - 6"	LF LF EA EA EA EA	688 931 14 13 6 15 3		
53 54 55 56 57 58 59 61 62 64	601.4.1.A.17C 601.4.1.A.17D 601.4.1.A.17E 601.4.1.A.1A 602.4.1.A.1A 602.4.1.A.1B 602.4.1.F.1A 602.4.1.F.1B 601.4.1.B.1B	18" Storm Drain Pipe, Type S, (CPP) 24" Storm Drain Pipe, Type S, (CPP) 30" Storm Drain Pipe, Type S, (CPP) Existing Storm Drain Connection Storm Drain Catch Manhole, 48" Diameter Storm Drain Catch Manhole, 60" Diameter Catch Basin - City of Lewiston Std (Type 1) Catch Basin - City of Lewiston Std (Type 1a) Inserta Tee - 6"	LF LF EA EA EA EA EA	688 931 14 13 6 15 3		
53 54 55 56 57 58 59 61 62 64	601.4.1.A.17C 601.4.1.A.17D 601.4.1.A.17E 601.4.1.C.1 602.4.1.A.1A 602.4.1.F.1A 602.4.1.F.1B 601.4.1.B.1B on 700 - Concres SP-707.1A	18" Storm Drain Pipe, Type S, (CPP) 24" Storm Drain Pipe, Type S, (CPP) 30" Storm Drain Pipe, Type S, (CPP) Existing Storm Drain Connection Storm Drain Catch Manhole, 48" Diameter Storm Drain Catch Manhole, 60" Diameter Catch Basin - City of Lewiston Std (Type 1) Catch Basin - City of Lewiston Std (Type 1a) Inserta Tee - 6"	LF LF EA EA EA EA EA	688 931 14 13 6 15 3 3		
53 54 55 56 57 58 59 61 62 64 Divisi 68 70	601.4.1.A.17C 601.4.1.A.17D 601.4.1.A.17E 601.4.1.C.1 602.4.1.A.1B 602.4.1.F.1A 602.4.1.F.1B 601.4.1.B.1B 601.4.1.B.1B 601.4.1.B.1B	18" Storm Drain Pipe, Type S, (CPP) 24" Storm Drain Pipe, Type S, (CPP) 30" Storm Drain Pipe, Type S, (CPP) Existing Storm Drain Connection Storm Drain Catch Manhole, 48" Diameter Storm Drain Catch Manhole, 60" Diameter Catch Basin - City of Lewiston Std (Type 1) Catch Basin - City of Lewiston Std (Type 1a) Inserta Tee - 6" Misc. Concrete Paving 6" Vertical Curb (No Gutter)	LF LF EA EA EA EA EA EA EA EA EA	688 931 14 13 6 15 3 3 65 199		
53 54 55 56 57 58 59 61 62 64 Divisi 68 70	601.4.1.A.17C 601.4.1.A.17D 601.4.1.A.17E 601.4.1.A.17E 602.4.1.A.1A 602.4.1.A.1B 602.4.1.F.1A 601.4.1.B.1B 601.4.1.B.1B 706.4.1.A.3	18" Storm Drain Pipe, Type S, (CPP) 24" Storm Drain Pipe, Type S, (CPP) 30" Storm Drain Pipe, Type S, (CPP) Existing Storm Drain Connection Storm Drain Catch Manhole, 48" Diameter Storm Drain Catch Manhole, 60" Diameter Catch Basin - City of Lewiston Std (Type 1) Catch Basin - City of Lewiston Std (Type 1a) Inserta Tee - 6" Misc. Concrete Paving 6" Vertical Curb (No Gutter) Standard 6-inch Vertical Curb & Gutter	LF LF EA EA EA EA EA LA EA LA	688 931 14 13 6 15 3 3 65 199 1,850		
53 54 55 56 57 58 59 61 62 64 Divisi 68 70 71 72	601.4.1.A.17C 601.4.1.A.17D 601.4.1.A.17E 601.4.1.A.17E 602.4.1.A.1A 602.4.1.F.1A 602.4.1.F.1B 601.4.1.B.1B 601.4.1.B.1B 601.4.1.B.1B 601.4.1.A.3 706.4.1.A.3	18" Storm Drain Pipe, Type S, (CPP) 24" Storm Drain Pipe, Type S, (CPP) 30" Storm Drain Pipe, Type S, (CPP) Existing Storm Drain Connection Storm Drain Catch Manhole, 48" Diameter Storm Drain Catch Manhole, 60" Diameter Catch Basin - City of Lewiston Std (Type 1) Catch Basin - City of Lewiston Std (Type 1a) Inserta Tee - 6" Misc. Concrete Paving 6" Vertical Curb (No Gutter) Standard 6-inch Vertical Curb & Gutter Concrete Sidewalk, thickness 4"	LF LF EA EA EA EA EA EA LF EA EA EA	688 931 14 13 6 15 3 3 65 199 1,850 1,075		
53 54 55 56 57 58 59 61 62 64 Divisi 68 70 71 72 73	601.4.1.A.17C 601.4.1.A.17D 601.4.1.A.17E 601.4.1.A.17E 602.4.1.A.1A 602.4.1.F.1A 602.4.1.F.1B 602.4.1.F.1B 706.4.1.F.1B 601.4.1.A.3	18" Storm Drain Pipe, Type S, (CPP) 24" Storm Drain Pipe, Type S, (CPP) 30" Storm Drain Pipe, Type S, (CPP) Existing Storm Drain Connection Storm Drain Catch Manhole, 48" Diameter Storm Drain Catch Manhole, 60" Diameter Catch Basin - City of Lewiston Std (Type 1) Catch Basin - City of Lewiston Std (Type 1a) Inserta Tee - 6" Misc. Concrete Paving 6" Vertical Curb (No Gutter) Standard 6-inch Vertical Curb & Gutter	LF LF EA EA EA EA EA EA EA SY LF LF SY SY	688 931 14 13 6 15 3 3 65 199 1,850 1,075 250		
53 54 55 56 57 58 59 61 62 64 Divisi 68 70 71	601.4.1.A.17C 601.4.1.A.17D 601.4.1.A.17E 601.4.1.A.17E 602.4.1.A.1A 602.4.1.F.1A 602.4.1.F.1B 601.4.1.B.1B 601.4.1.B.1B 601.4.1.B.1B 601.4.1.A.3 706.4.1.A.3	18" Storm Drain Pipe, Type S, (CPP) 24" Storm Drain Pipe, Type S, (CPP) 30" Storm Drain Pipe, Type S, (CPP) Existing Storm Drain Connection Storm Drain Catch Manhole, 48" Diameter Storm Drain Catch Manhole, 60" Diameter Catch Basin - City of Lewiston Std (Type 1) Catch Basin - City of Lewiston Std (Type 1a) Inserta Tee - 6" Misc. Concrete Paving 6" Vertical Curb (No Gutter) Standard 6-inch Vertical Curb & Gutter Concrete Sidewalk, thickness 4" Concrete Driveway Approach	LF LF EA EA EA EA EA EA LF EA EA EA	688 931 14 13 6 15 3 3 65 199 1,850 1,075		

DOWNTOWN IRRP 2016 BASE BID (CONTINUED)CITY OF LEWISTON

Item	Bid Item	Description of Item			Es	timate
No.	No.		Unit	Quantity	Price	Amount
Divisi	on 800 - Aggreg	ates and Asphalt				
76	802.4.1.A.1	Crushed Aggregate for Base, Type 1	CY	1047		
77	810.4.1.A.3	Plant Mix Pavement - 4"	SY	6,282		
78	810.4.4.A.5	Miscellaneous Paving	SY	381		
80	SP-810.B	Crack seal and Pavement Sealer,	SY	2192		
Divisi		ruction Stormwater BMPs				
	1001.4.1.A.1	Sediment Control	LS	1		
	1001.4.2.A.1	Staging area	EA	1		
	1001.4.2.B.1	Stabilized Construction Entrance	EA	1		
	1006.4.1.C.1	Inlet Protection	EA	16		
Divisi	 on 1100 – Traff	ic				
102	1102.4.1.E.1	Conduit, Size 2"	LF	1,563		
103	1102.4.1.F.1	Junction Box	EA	4		
	1103.4.1.B.1	Construction Traffic Control	LS	1		
81	1104.4.1.A.1	Painted Pavement Marking,	SF	560		
82	SP-1105.A	Remove and Reset Sign	EA	17		
***	2000 151					
Divisi	on 2000 - Misce		1.0			
	2010.4.1.A.1	Mobilization	LS	1		
83	2020.4.1.F.1	Reference and Reset Monuments	EA	6		
84	2030.4.1.A.1	Manhole, Adjust to Grade	EA	7		
85	2030.4.1.C.1	Valve Box, Adjust to Grade	EA	1		
91	SP-706.A	Sidewalk Roof Drain	EA	5		
89	SP-221	Planter Bed Excavation	CY	42		
90	SP-222	Top Soil from Stockpile, Type S1	CY	42		
	2050.4.1.C.1	Subgrade Seperation Geotextile Fabric, Type 1	SY	6278		
	SP-2000A	Project Quality Control	LS	1		

DOWNTOWN IRRP 2016 ADD ALTERNATE 1

CITY OF LEWISTON

Item	Bid Item	Description of Item			Es	timate
No.	No.		Unit	Quantity	Price	Amount
Divisi	on 200 - Earthw	ork				
2	201.4.1.D.1A	Removal of Sidewalk	SY	17		
3	201.4.1.D.1B	Removal of Bituminous Surface	SY	22		
4	201.4.1.E.1	Removal of Curb	LF	14		
6	201.4.1.F.2	Removal of Catch Basin	EA	1		
9	SP-201.C	Abandon Pipe In place (Grout Fill)	CY	4.65		
93	201.4.1.B.1	Clearing and Grubbing	AC	0.27		
94	206.4.1.K.1	Complete Seeding	AC	0.27		
99	206.4.1.H.3	Loose Riprap	CY	15.00		
Divisi	on 600 - Storm 1	Drains				
54	601.4.1.A.17C	18" Storm Drain Pipe, Type S, (CPP)	LF	218		
57	601.4.1.C.1	Existing Storm Drain Connection	EA	2		
58	602.4.1.A.1A	Storm Drain Catch Manhole, 48" Diameter	EA	1		
Divisi	on 700 - Concret	te				
67	SP-704.A	Concrete Headwall 18"	EA	3		
71	706.4.1.A.5	Standard 6-inch Vertical Curb & Gutter	LF	14		
72	706.4.1.E.1	Concrete Sidewalk, thickness 4"	SY	17		
Divisi	on 1000 - Constr	ruction Stormwater BMPs				
	1001.4.1.A.1	Sediment Control	LS	1		
	1001.4.2.B.1	Stabilized Construction Entrance	EA	1		
	1006.4.1.C.1	Inlet Protection	EA	1		
Divisi	on 1100 – Traffi	c				
	1103.4.1.B.1	Construction Traffic Control	LS	1		
Divisi	on 2000 – Misce	llaneous				
	2010.4.1.A.1	Mobilization	LS	1		
100	2050.4.1.B.1	Riprap/Erosion Control Geotextile	SY	15		
	SP-2000A	Project Quality Control	LS	1		

DOWNTOWN IRRP 2016 ADD ALTERNATE 2

CITY OF LEWISTON

Item	Bid Item	Description of Item			Es	stimate
No.	No.	-	Unit	Quantity	Price	Amoun
Divisi	on 200 - Earthw	ork				
1	201.4.1.C.1	Removal of Obstructions	EA	6		
2	201.4.1.D.1A	Removal of Sidewalk	SY	7		
3	201.4.1.D.1B	Removal of Bituminous Surface	SY	233		
4	201.4.1.E.1	Removal of Curb	LF	5		
7	SP-201.A	Abandon Pipe In Place (Plug End)	EA	11		
8	SP-201.B	Abandon Pipe Removal	LF	38		
10	202.4.1.A.1	Excavation	CY	450		
11	201.4.1.D.1C	Removal of Concrete w/ Ashpalt overlay	SY	1,245		
Divisi	on 400 - Water					
15	401.4.1.A.1A	Water Main Pipe - Size 4" - DI - Class 350	LF	4		
16	401.4.1.A.1B	Water Main Pipe - Size 6" - DI - Class 350	LF	24		
18	401.4.1.A.1D	Water Main Pipe - Size 10" - DI - Class 350	LF	461		
19	401.4.1.B.1	Water Main Fitting - Size " - DI	EA	9		
20	401.4.1.C.1A	Connect to Existing Main - 4"	EA	4		
23	401.4.1.C.1D	Connect to Existing Main - 10"	EA	1		
24	402.4.1.A.1A	Valve - Size 4"	EA	4		
25	402.4.1.A.1B	Valve - Size 6"	EA	1		
28	403.4.1.A.1	Hydrant	EA	1		
29	404.4.1.A.1	Water Service Connection, No Meter, Size ,	EA	1		
30	404.4.1.B.1	Connect to Existing Service Pipe, Size ",	EA	3		
33	404.4.1.C.1A	Water Service Pipe 3/4" or 1"	LF	42		
34	404.4.1.C.1B	Water Service Pipe 1 1/4" or 1 1/2"	LF	0		
35	404.4.1.C.1C	Water Service Pipe 2"	LF	13		
	on 500 – Sewer		- n			
38	502.4.1.A.1	Sanitary Sewer Manhole - Type A	EA	1		
39	507.4.1.D.3	Install 8" Full Circle Repair Clamp	EA	1		
41	507.4.1.E.1B	Replace 8" Dia. Pipe	LF	15		
44	507.4.1.H.3	Remove Flush Tank	EA	1		
Divisi	on 600 - Storm	Drains				
49	601.4.1.A.5A	12" Storm Drain Pipe, Class C900, (PVC)	LF	24		
52	601.4.1.A.17A	12" Storm Drain Pipe, Type S, (CPP)	LF	214		
57	601.4.1.C.1	Existing Storm Drain Connection	EA	1		
58	602.4.1.A.1A	Storm Drain Catch Manhole, 48" Diameter	EA	1		
Dinini	on 700 - Concre	4-				
71	706.4.1.A.5	Standard 6-inch Vertical Curb & Gutter	LF	5		
72	706.4.1.E.1	Concrete Sidewalk, thickness 4"	SY	6		
	•					
		ates and Asphalt	CV	250		I
	802.4.1.A.1	Crushed Aggregate for Base, Type 1	CY	250		
	810.4.1.A.3 810.4.4.A.5	Plant Mix Pavement - 4"	SY	1,478		
78	1010.4.4.A.3	Miscellaneous Paving	SY	1		
Divisi	on 1000 - Const	ruction Stormwater BMPs				
	1001.4.1.A.1	Sediment Control	LS	1		
	1006.4.1.C.1	Inlet Protection	EA	2		
D: : :	1100 ==================================					
	on 1100 – Traffi	Conduit, Size 2"	I E	450		
102	1102.4.1.E.1 1103.4.1.B.1		LF LS	450 1		
	[1103.4.1.B.1	Construction Traffic Control	LS	1		
Divisi	on 2000 – Misce	llaneous				
	2010.4.1.A.1	Mobilization	LS	1		
84	2030.4.1.A.1	Manhole, Adjust to Grade	EA	1		
	2030.4.1.C.1	Valve Box, Adjust to Grade	EA	1		
85						1
85	2050.4.1.C.1 SP-2000A	Subgrade Seperation Geotextile Fabric, Type 1 Project Quality Control	LS	1476 1		



BID DOCUMENTS

					SCALE	WARNING
					HORIZONTAL	0 1/2 1
					NA	
					VERTICAL	THIS BAR MEASURES 1/2" ON 11"x17" SHEET
νο.	DATE	FILENAME	DESCRIPTION	BY	NA	1" ON 22"x34" SHEET
			REVISIONS		ING	WHEN PLOTTED TO SCALE

CITY OF LEWISTON PUBLIC WORKS DEPARTMENT ENGINEERING SERVICES
215 'D' STREET, LEWISTON, ID 83501 208-746-1316 FAX 208-746-5595



DOWNTOWN INFRASTRUCTURE REPAIR AND REPLACEMENT PROJECT (IRRP-2016)

QUANTITY SUMMARY SHEET

DESIGNED BY:	DATE:	PROJECT:
J. KAUFMAN	2015	IRRP-2016
DRAWN BY:	DATE:	SHEET
B. STEWART	12-16-2015	6 _{OF} 89
CHECKED BY:	DATE:	DRAWING: C
S. STUBBERS	01-14-2016	G-6

DOWNTOWN IRRP 2016 ADD ALTERNATE 3

CITY OF LEWISTON

Item	Bid Item	Description of Item			Es	timate
No.	No.		Unit	Quantity	Price	Amount
Divisi	ion 200 - Earthwe	ork				
2	201.4.1.D.1A	Removal of Sidewalk	SY	8		
3	201.4.1.D.1B	Removal of Bituminous Surface	SY	537		
4	201.4.1.E.1	Removal of Curb	LF	15		
6	201.4.1.F.2	Removal of Catch Basin	EA	3		
9	SP-201.C	Abandon Pipe In place (Grout Fill)	CY	13		
Divie	ion 300 - Trenchi	ma				
13	307.4.1.G.1	Main Line Type "P" Surface Restoration (Asphalt Roadway)	SY	537		
Divisi	ion 400 - Water					
30	404.4.1.B.1	Connect to Existing Service Pipe, Size ",	EA	3		
31	SP-404A	Potable Water Main Crossing	EA	1		
32	SP-404B	Potable Water Lateral Crossing	EA	4		
33	404.4.1.C.1A	Water Service Pipe 3/4" or 1"	LF	41		
Divisi	ion 600 - Storm D	Drains				
49	601.4.1.A.5A	12" Storm Drain Pipe, Class C900, (PVC)	LF	20		
52	601.4.1.A.17A	12" Storm Drain Pipe, Type S, (CPP)	LF	8		
54	601.4.1.A.17C	18" Storm Drain Pipe, Type S, (CPP)	LF	438		
57	601.4.1.C.1	Existing Storm Drain Connection	EA	1		
58	602.4.1.A.1A	Storm Drain Catch Manhole, 48" Diameter	EA	2		
61	602.4.1.F.1A	Catch Basin - City of Lewiston Std (Type 1)	EA	2		
Dinin	ion 700 - Concret					
71	706.4.1.A.5	Standard 6-inch Vertical Curb & Gutter	LF	15		
72	706.4.1.E.1	Concrete Sidewalk, thickness 4"	SY	7		
	700. I.I.B.I	Concrete Side walk, unexhibits	101	,		
Divisi	ion 1000 - Constr	uction Stormwater BMPs				
	1001.4.1.A.1	Sediment Control	LS	1		
	1006.4.1.C.1	Inlet Protection	EA	3		
D: ::	. 1100 25 22	<u> </u>				
Divisi	ion 1100 – Traffic 1103.4.1.B.1	Construction Traffic Control	LS	1		
	[1105.4.1.B.1	Construction Traffic Control	LLS	1		
Divisi	ion 2000 – Miscel	llaneous				
	2010.4.1.A.1	Mobilization	LS	1		
	SP-2000A	Project Quality Control	LS	1		

DOWNTOWN IRRP 2016 ADD ALTERNATE 4

CITY OF LEWISTON

Item	Bid Item	Description of Item			Est	imate
No.	No.		Unit	Quantity	Price	Amount
Divisi	on 200 - Earthw	ork				
1	201.4.1.C.1	Removal of Obstructions	EA	2		
2	201.4.1.D.1A	Removal of Sidewalk	SY	10		
3	201.4.1.D.1B	Removal of Bituminous Surface	SY	986		
4	201.4.1.E.1	Removal of Curb	LF	42		
6	201.4.1.F.2	Removal of Catch Basin	EA	6		
7	SP-201.A	Abandon Pipe In Place (Plug End)	EA	15		
10	202.4.1.A.1	Excavation	CY	4		
Divisi	on 300 - Trench	 ing				
13	307.4.1.G.1	Main Line Type "P" Surface Restoration (Asphalt Roadway)	SY	363		
Divisi	on 400 - Water					
31	SP-404A	Potable Water Main Crossing	EA	4		
32	SP-404B	Potable Water Lateral Crossing	EA	2		
D:.:-:		Danis -				
	on 600 - Storm I		1.0	07		
49	601.4.1.A.5A	12" Storm Drain Pipe, Class C900, (PVC)	LF	97		
52	601.4.1.A.17A	12" Storm Drain Pipe, Type S, (CPP)	LF	585		
57	601.4.1.C.1	Existing Storm Drain Connection	EA	2		
58	602.4.1.A.1A	Storm Drain Catch Manhole, 48" Diameter	EA	4		
61	602.4.1.F.1A	Catch Basin - City of Lewiston Std (Type 1)	EA	6		
Divisi	on 700 - Concre	te			l.	
71	706.4.1.A.5	Standard 6-inch Vertical Curb & Gutter	LF	42		
72	706.4.1.E.1	Concrete Sidewalk, thickness 4"	SY	10		
74	706.4.1.H.1	Pedestrian Ramp w/ Detectable Warning Domes, Type	EA	1		
	•				,	
Divisi	on 800 - Aggreg	ates and Asphalt				
76	802.4.1.A.1	Crushed Aggregate for Base, Type 1	CY	106		
77	810.4.1.A.3	Plant Mix Pavement - 4"	SY	632		
Divisi	on 1000 - Const	ruction Stormwater BMPs				
25 17 151	1001.4.1.A.1	Sediment Control	LS	1		
	1006.4.1.C.1	Inlet Protection	EA	6		
Divisi	on 1100 – Traffi	c				
	1103.4.1.B.1	Construction Traffic Control	LS	1		
Divisi	on 2000 – Misce	llaneous				
Dirist	2010.4.1.A.1	Mobilization	LS	1		
83	2020.4.1.F.1	Reference and Reset Monuments	EA	1		
85	2020.4.1.F.1 2030.4.1.C.1	Valve Box, Adjust to Grade	EA	2		
0.5	SP-2000A	Project Quality Control	LS	1		
	DI 2000A	12 roject Quanty Control	120			

DOWNTOWN IRRP 2016 ADD ALTERNATE 5

CITY OF LEWISTON

Item	Bid Item	Description of Item			Est	imate
No.	No.	-	Unit	Quantity	Price	Amount
Divisio	on 200 - Earthw					
3	201.4.1.D.1B	Removal of Bituminous Surface	SY	247		
5	201.4.1.F.1	Removal of Manhole	EA	1		
6	201.4.1.F.2	Removal of Catch Basin	EA	4		
7	SP-201.A	Abandon Pipe In Place (Plug End)	EA	6		
	on 400 - Water	I				
32	SP-404B	Potable Water Lateral Crossing	EA	1		
Dinini	 on 500 – Sewer					
47	SP-507B	Sanitary Sewer Main Crossing	EA	1		
4/	SF-307B	Samary Sewer Main Crossing	EA	1		
Divisio	on 600 - Storm 1	Drains				
49	601.4.1.A.5A	12" Storm Drain Pipe, Class C900, (PVC)	LF	30		
52	601.4.1.A.17A	12" Storm Drain Pipe, Type S, (CPP)	LF	52		
57	601.4.1.C.1	Existing Storm Drain Connection	EA	2		
58	602.4.1.A.1A	Storm Drain Catch Manhole, 48" Diameter	EA	1		
60	602.4.1.S.1	Special Inlet (4'x6'x6'-6" Conc. Vault with Grated Inlet),	EA	1		
61	602.4.1.F.1A	Catch Basin - City of Lewiston Std (Type 1)	EA	1		
65	SP-604.4A	Special Pipe (48" Storm Drain Pipe, Type S, Corrugated Polyethylene (CPP) Perforated provided by City of Lewiston),	LF	124		
66	SP-604.4B	Special Fitting, 48" x 12" Dual Wall Fabricated Reducer, Corrugated Polyethylene (CPP), (Hancor 4874AN85B or equal),	EA	1		
		ates and Asphalt				
76	802.4.1.A.1	Crushed Aggregate for Base, Type 1	CY	11		
78	810.4.4.A.5	Miscellaneous Paving	SY	247		
Diniai	on 1000 Countr	ruction Stormwater BMPs				
Divisi	1001.4.1.A.1	Sediment Control	LS	1		
	1001.4.1.A.1 1006.4.1.C.1	Inlet Protection	EA	2		
	1000.4.1.0.1	Thet I folection	EA			
Divisi	on 1100 — Traffi	c				
	1103.4.1.B.1	Construction Traffic Control	LS	1		
Divisi	on 2000 – Misce	llaneous				
	2010.4.1.A.1	Mobilization	LS	1		
	SP-2000A	Project Quality Control	LS	1		
	·		_			· ·



BID DOCUMENTS

SCALE
HORIZONTAL
HORIZONTAL
NA

THIS BAR MEASURES
1/2" ON 11"x17" SHEET
1" ON 22"x34" SHEET
WHEN PLOTTED TO SCALE

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SHEET
SHEET


CITY OF LEWISTON
PUBLIC WORKS DEPARTMENT
ENGINEERING SERVICES
215 'D' STREET, LEWISTON, ID 83501
208-746-1316
FAX 208-746-5595





DOWNTOWN INFRASTRUCTURE REPAIR
AND REPLACEMENT PROJECT (IRRP-2016)


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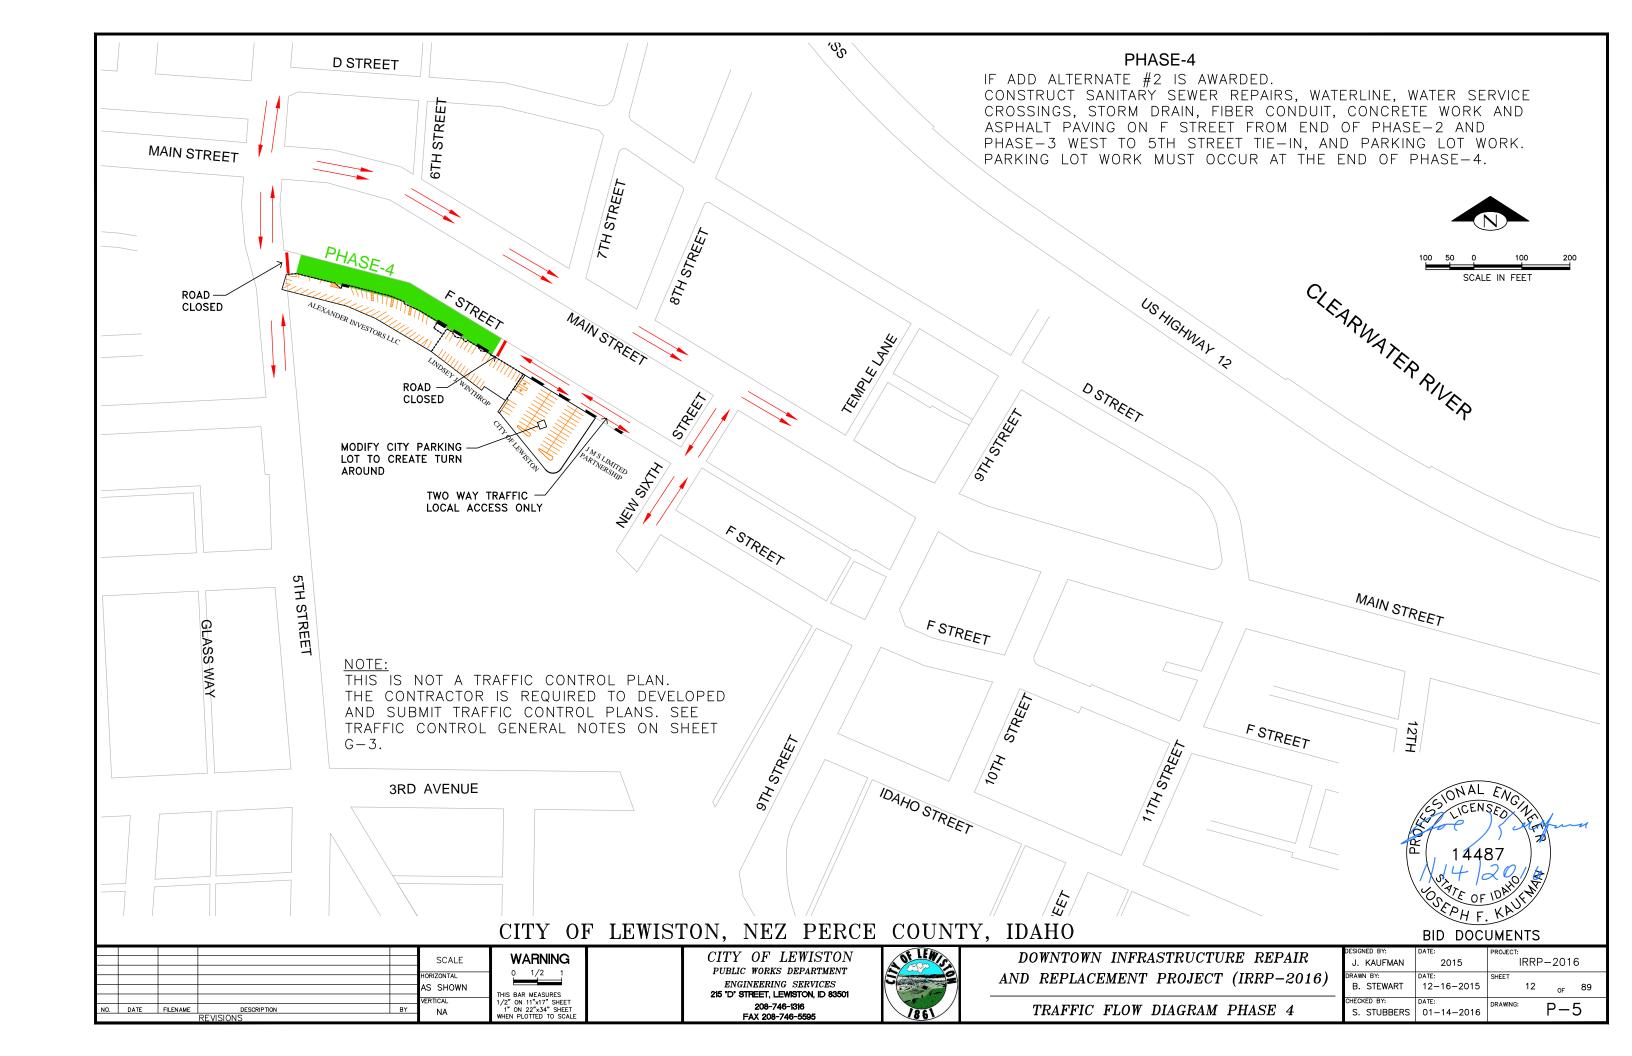
BID DOCOMENIS			
DESIGNED BY: J. KAUFMAN	DATE: 2015	PROJECT: IRRP-2016	
DRAWN BY:	DATE:		
B. STEWART	12-16-2015	SHEET 7 OF 89	
CHECKED BY: S. STUBBERS	DATE: 01-14-2016	DRAWING: G-7	




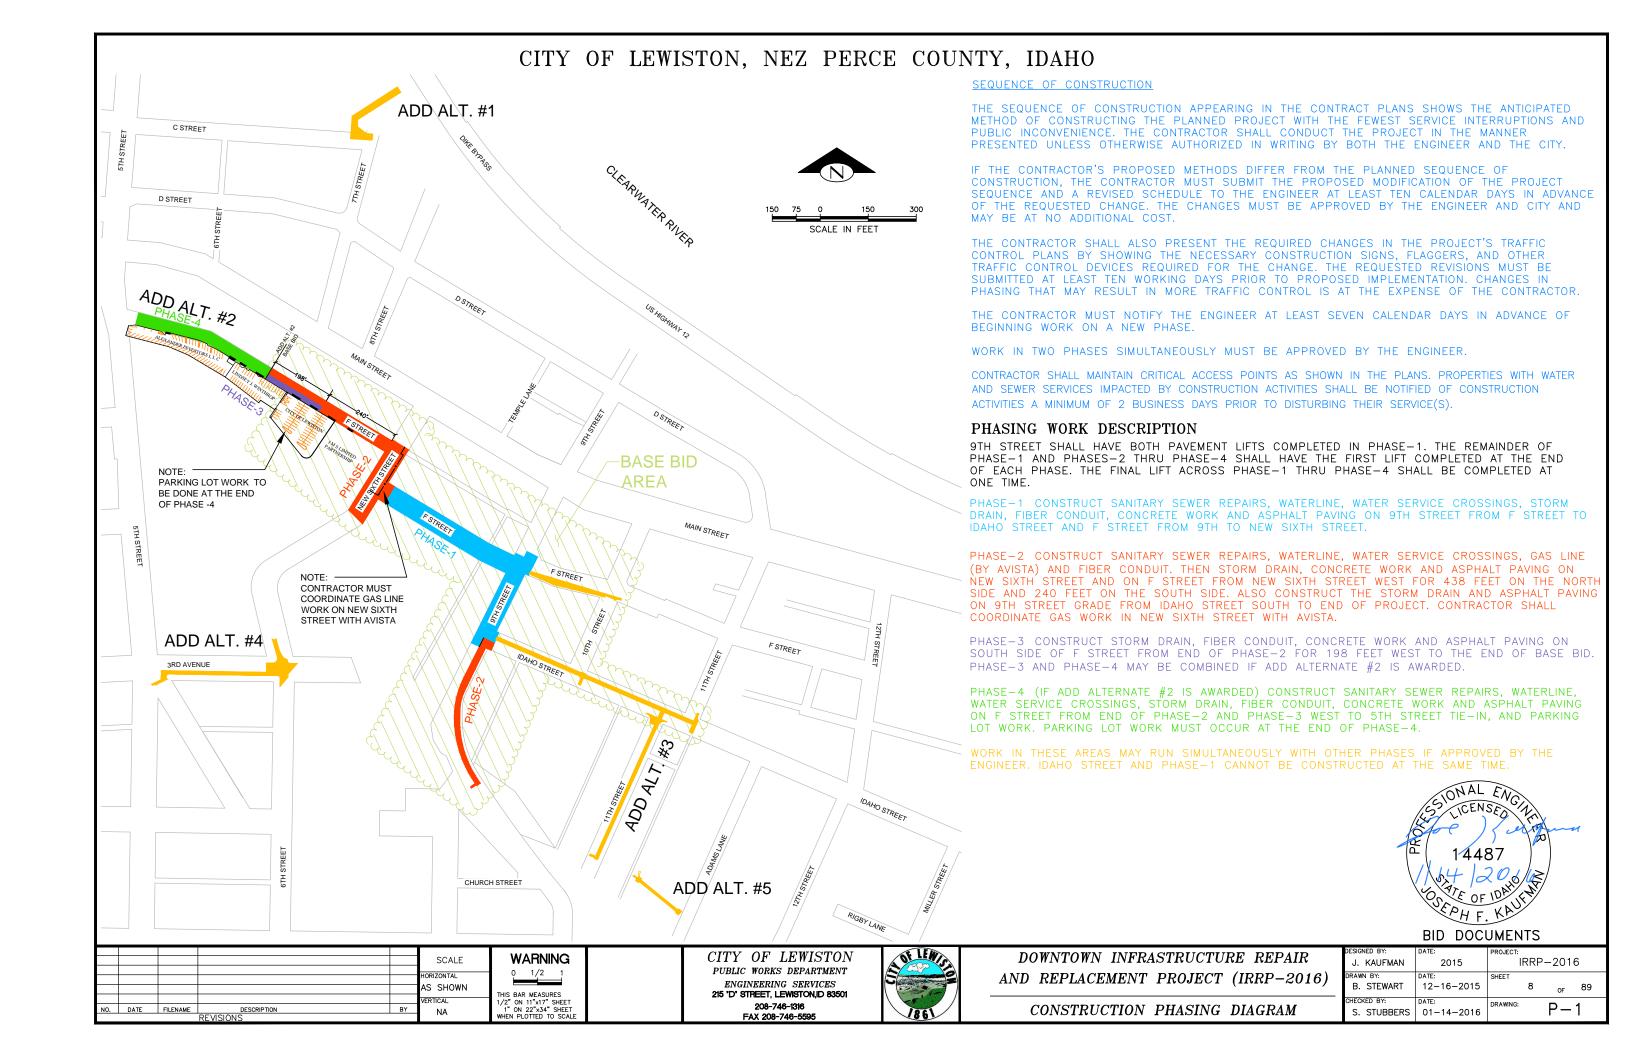


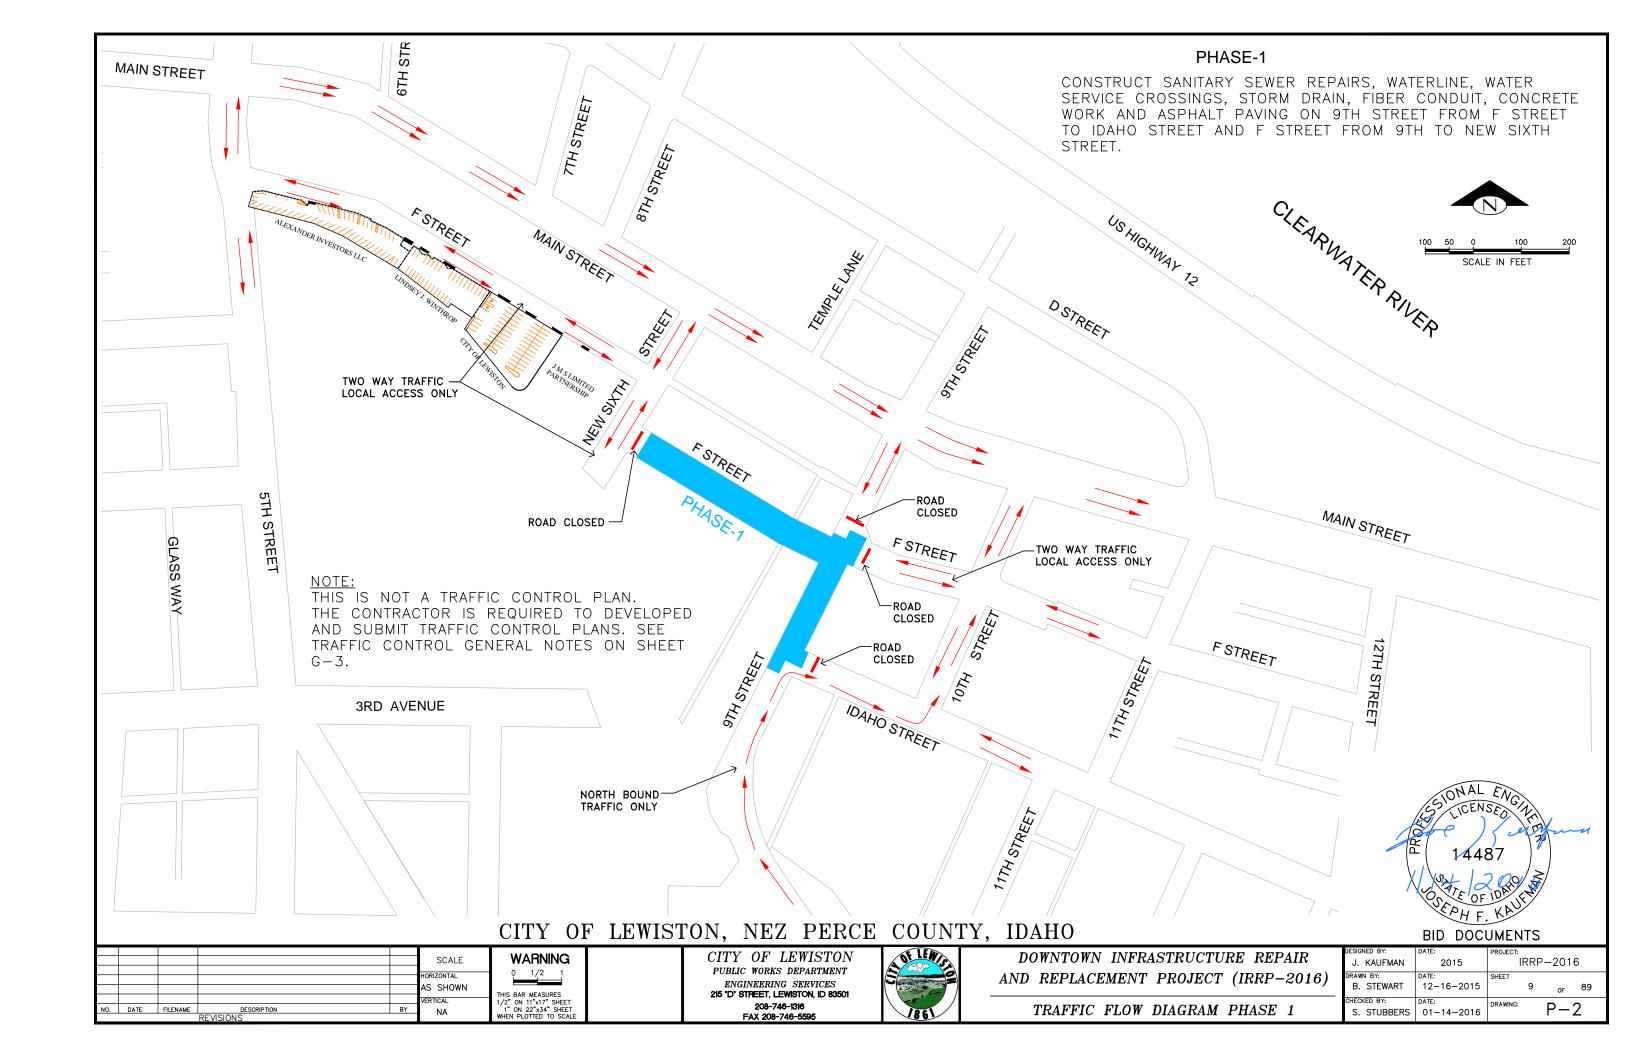


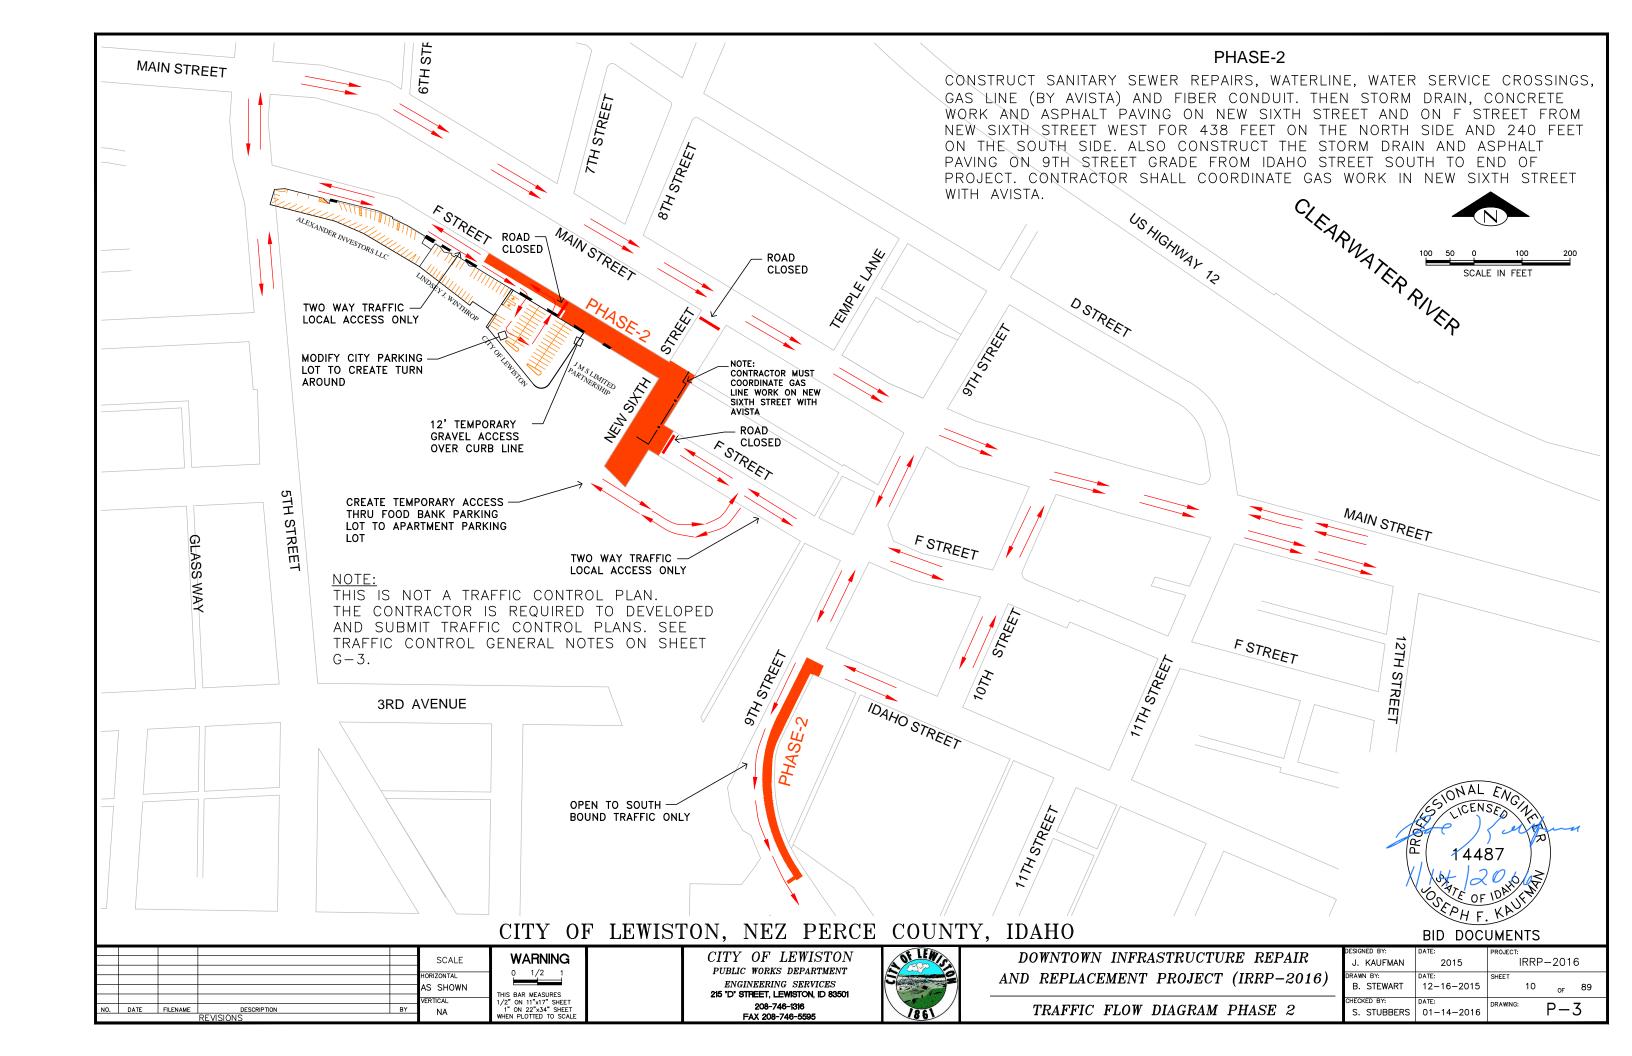


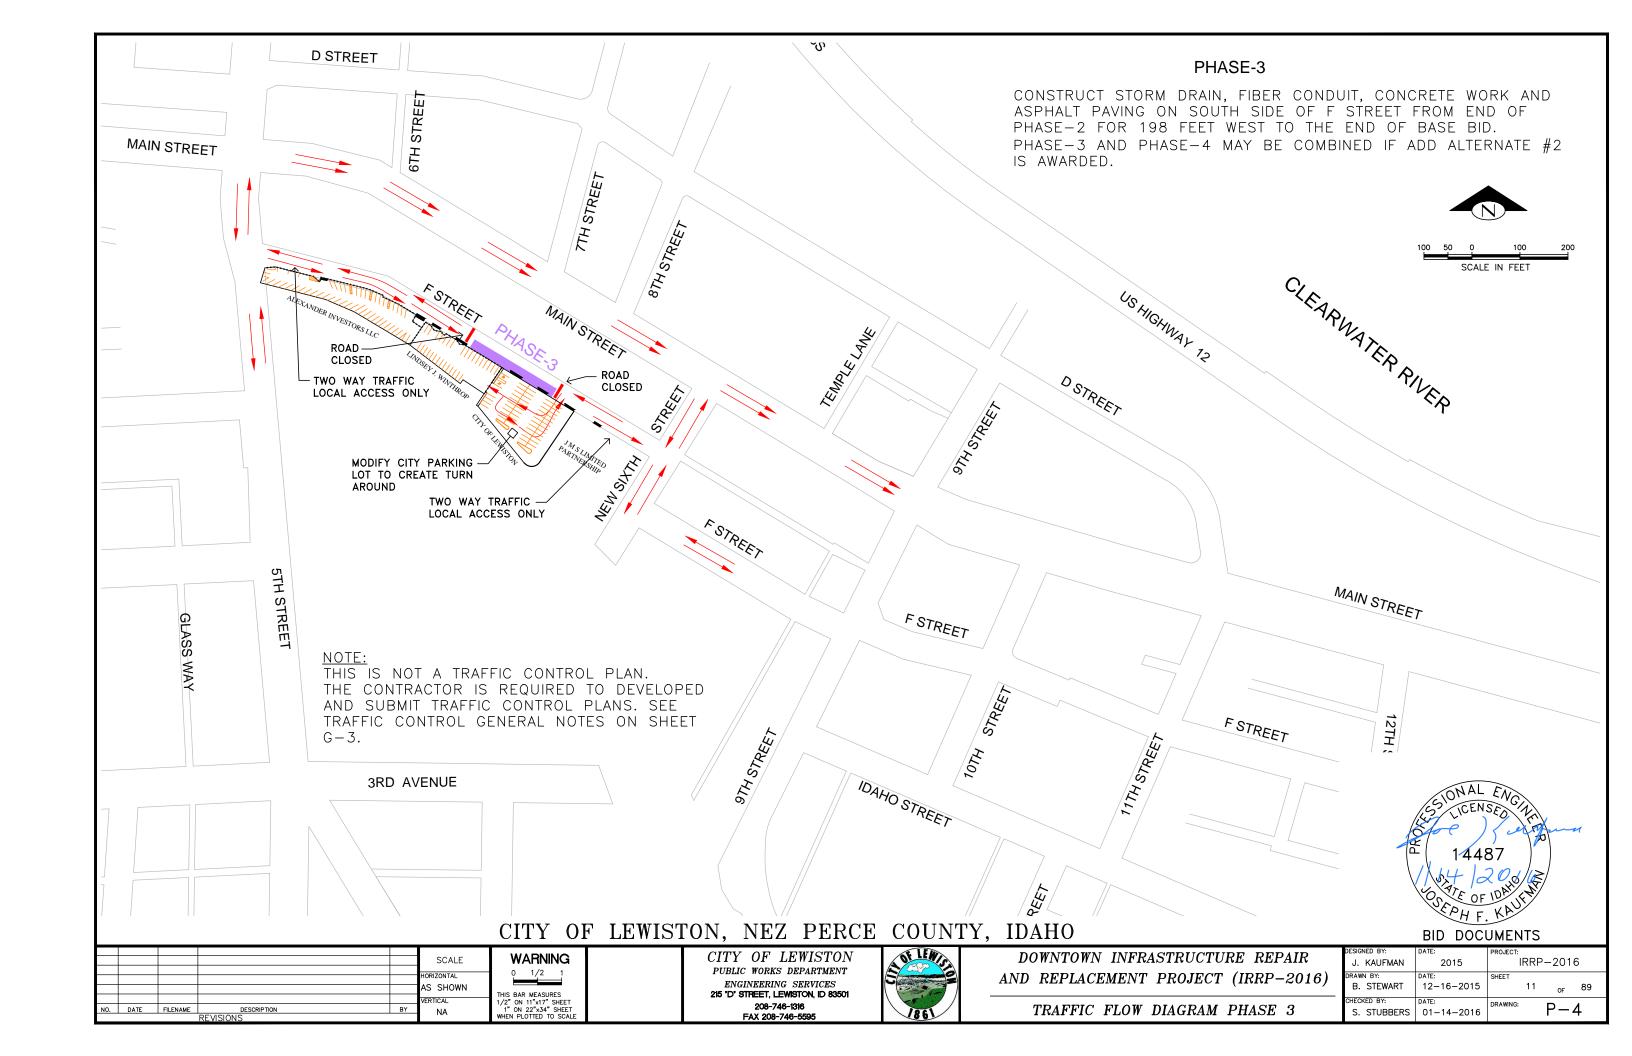


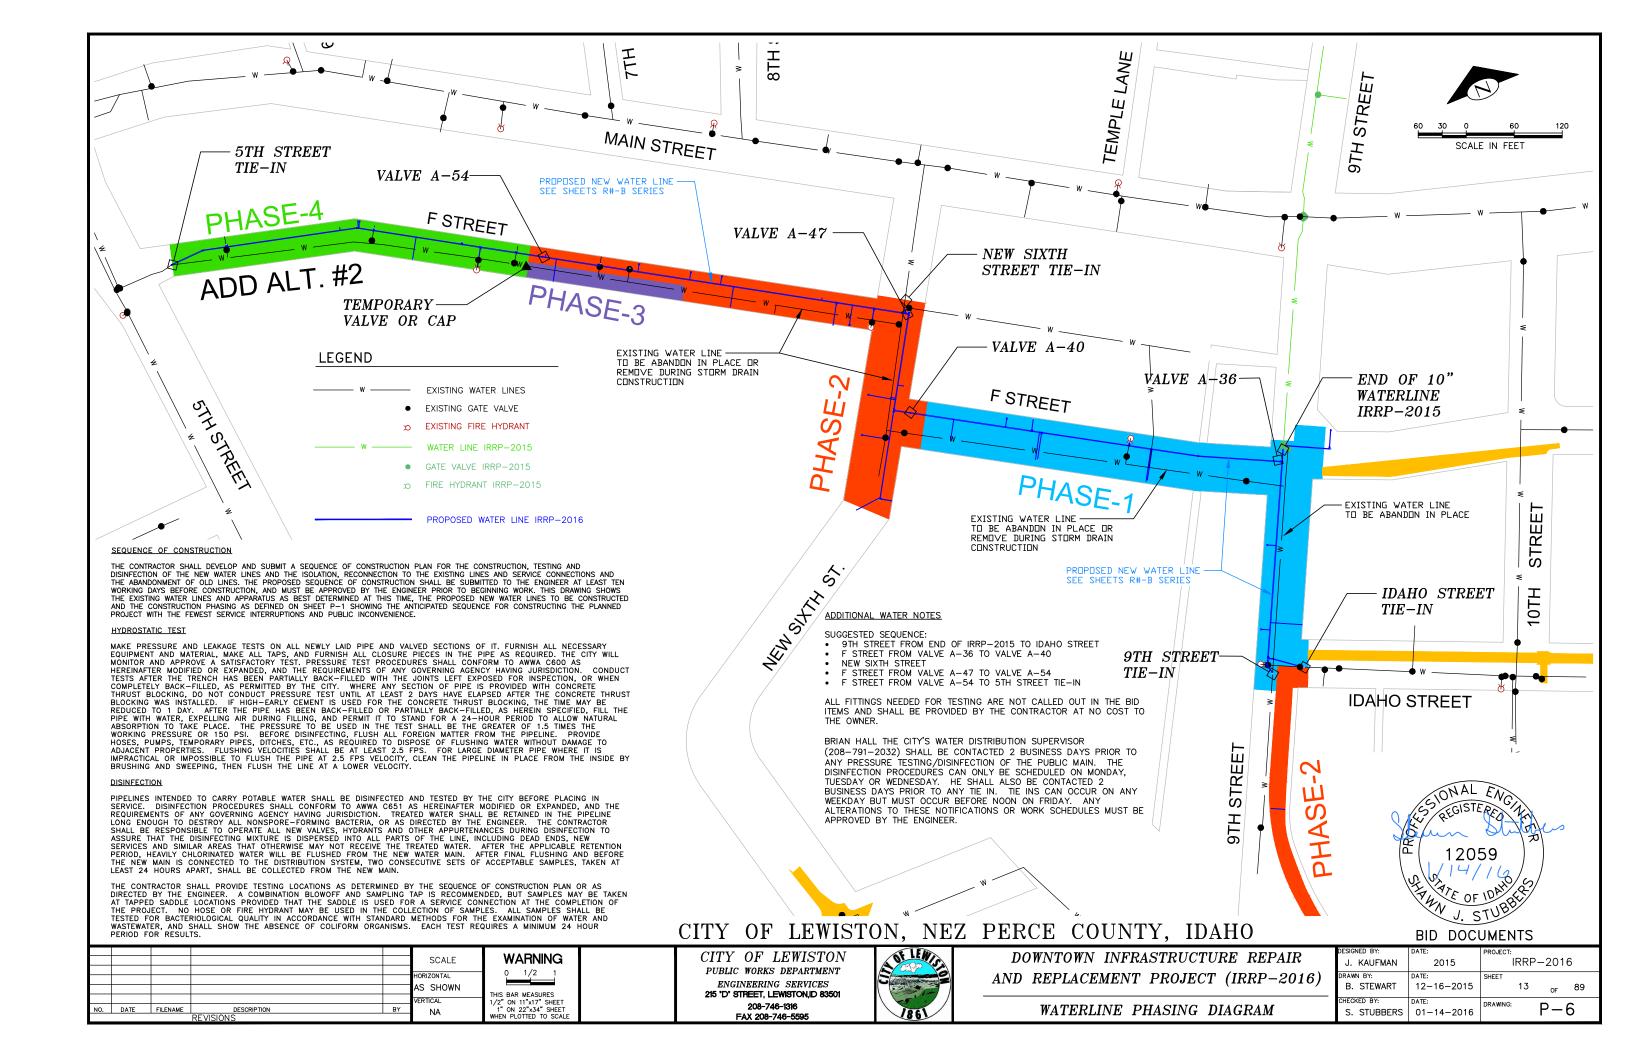


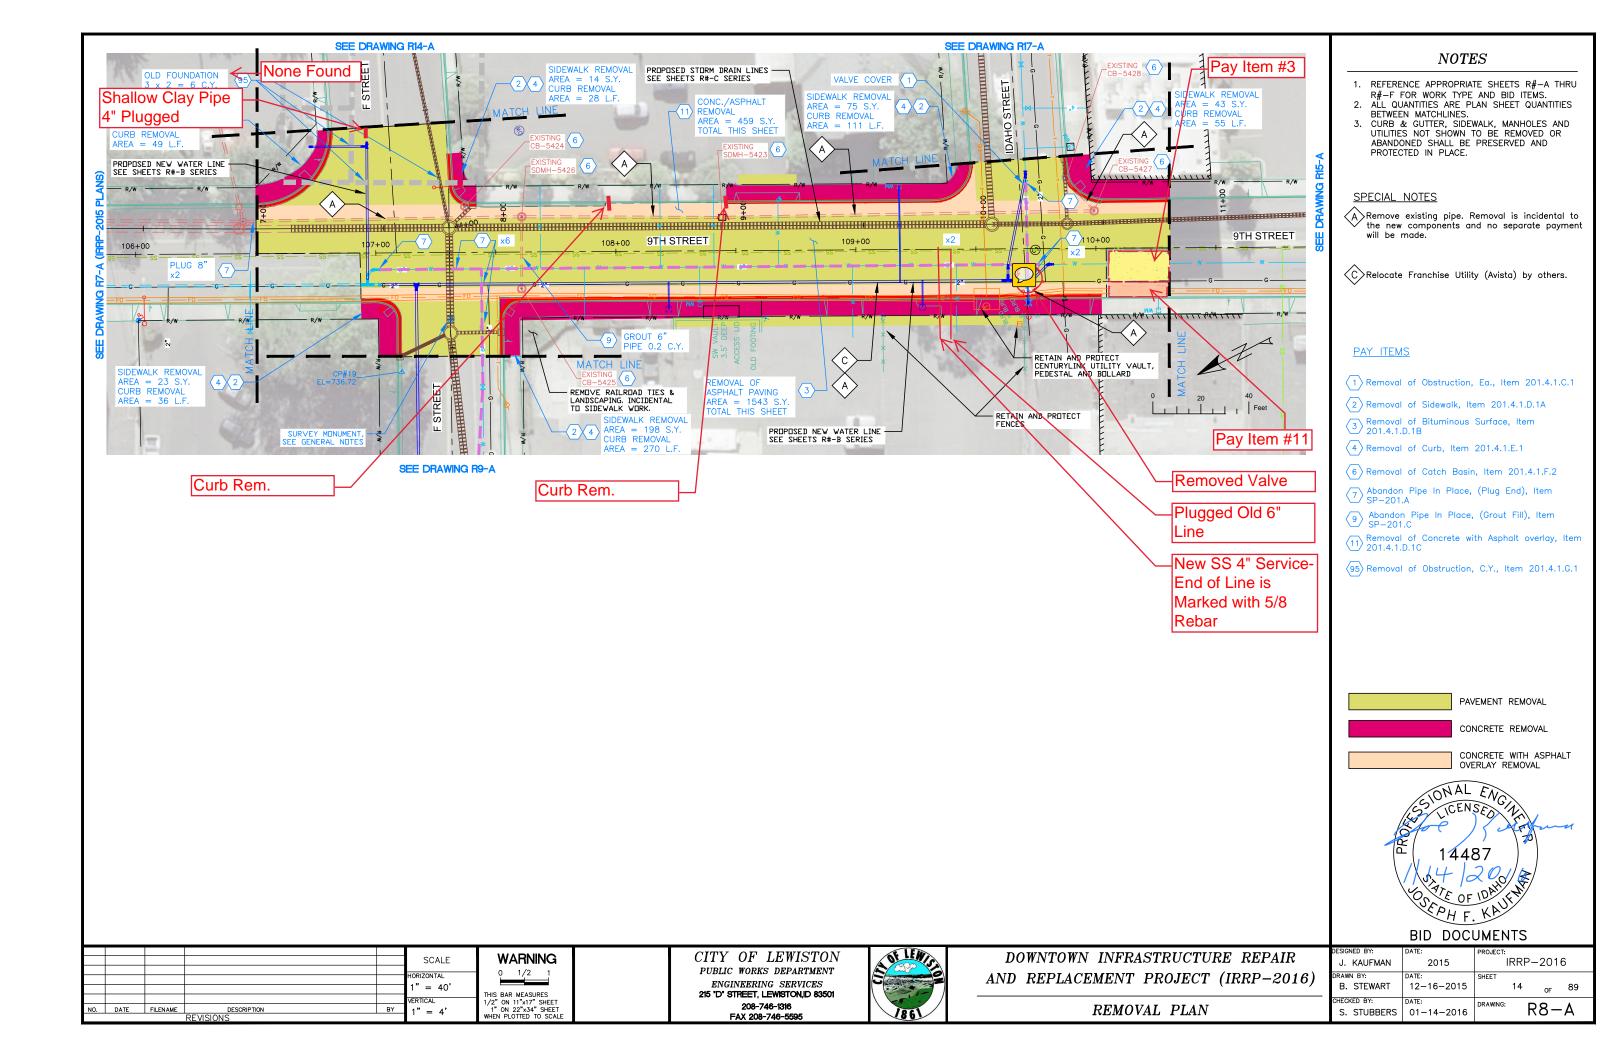


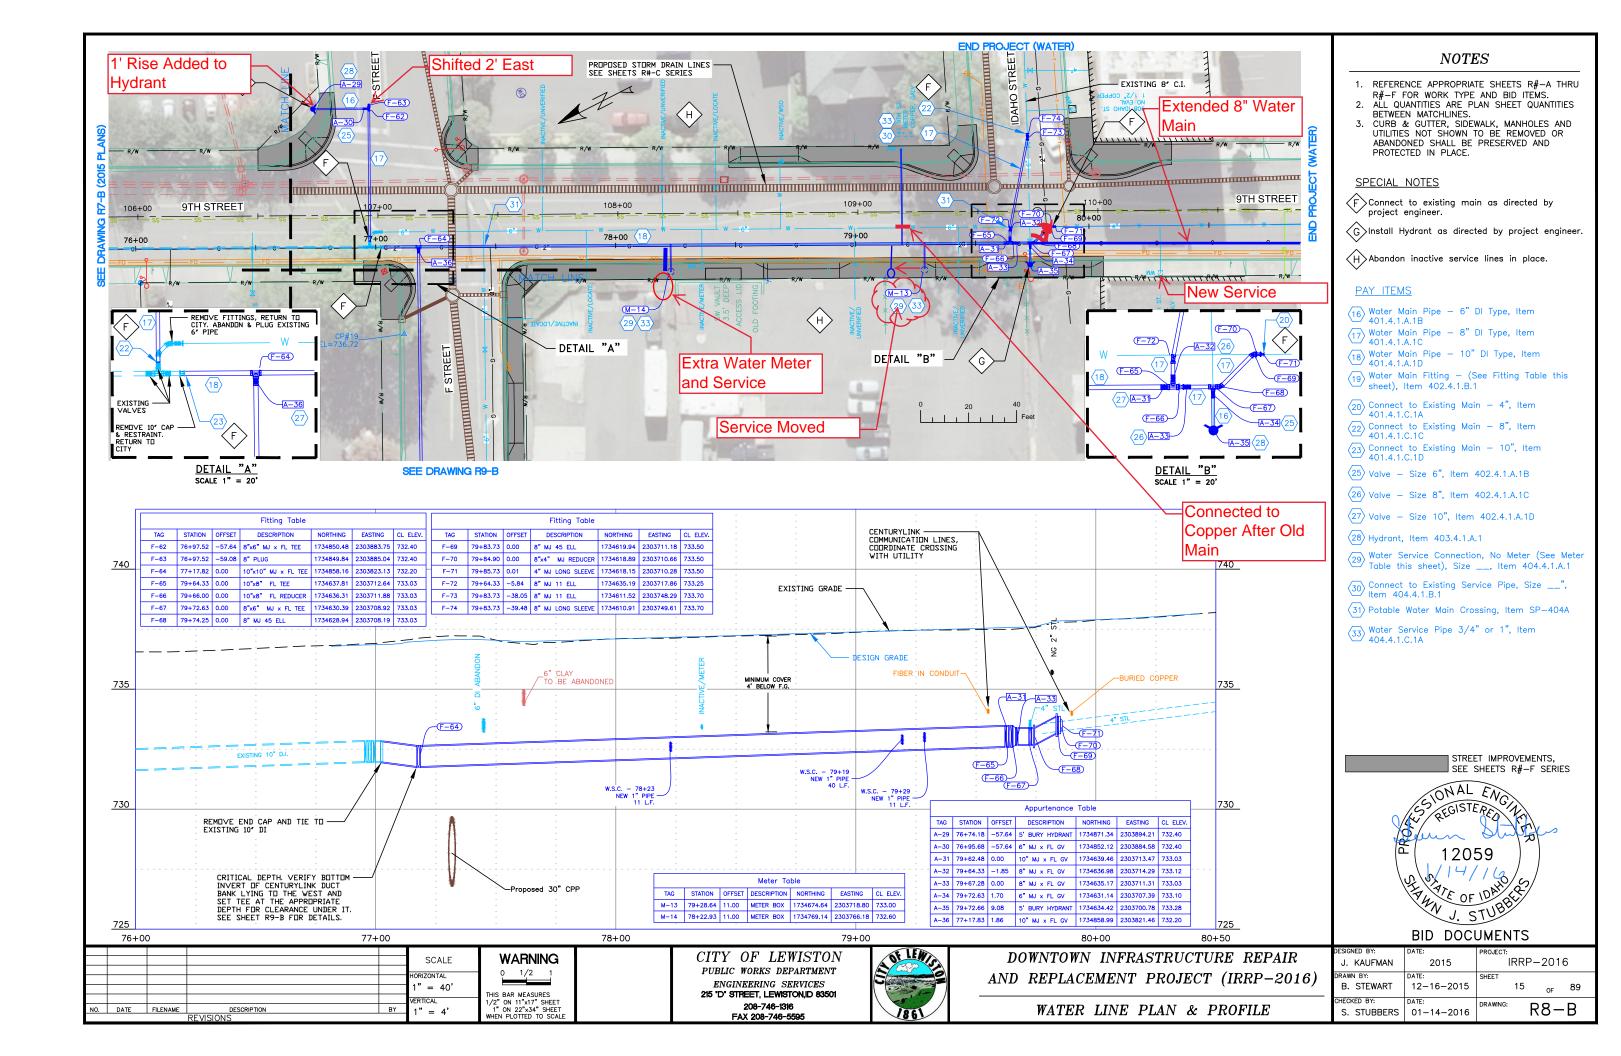

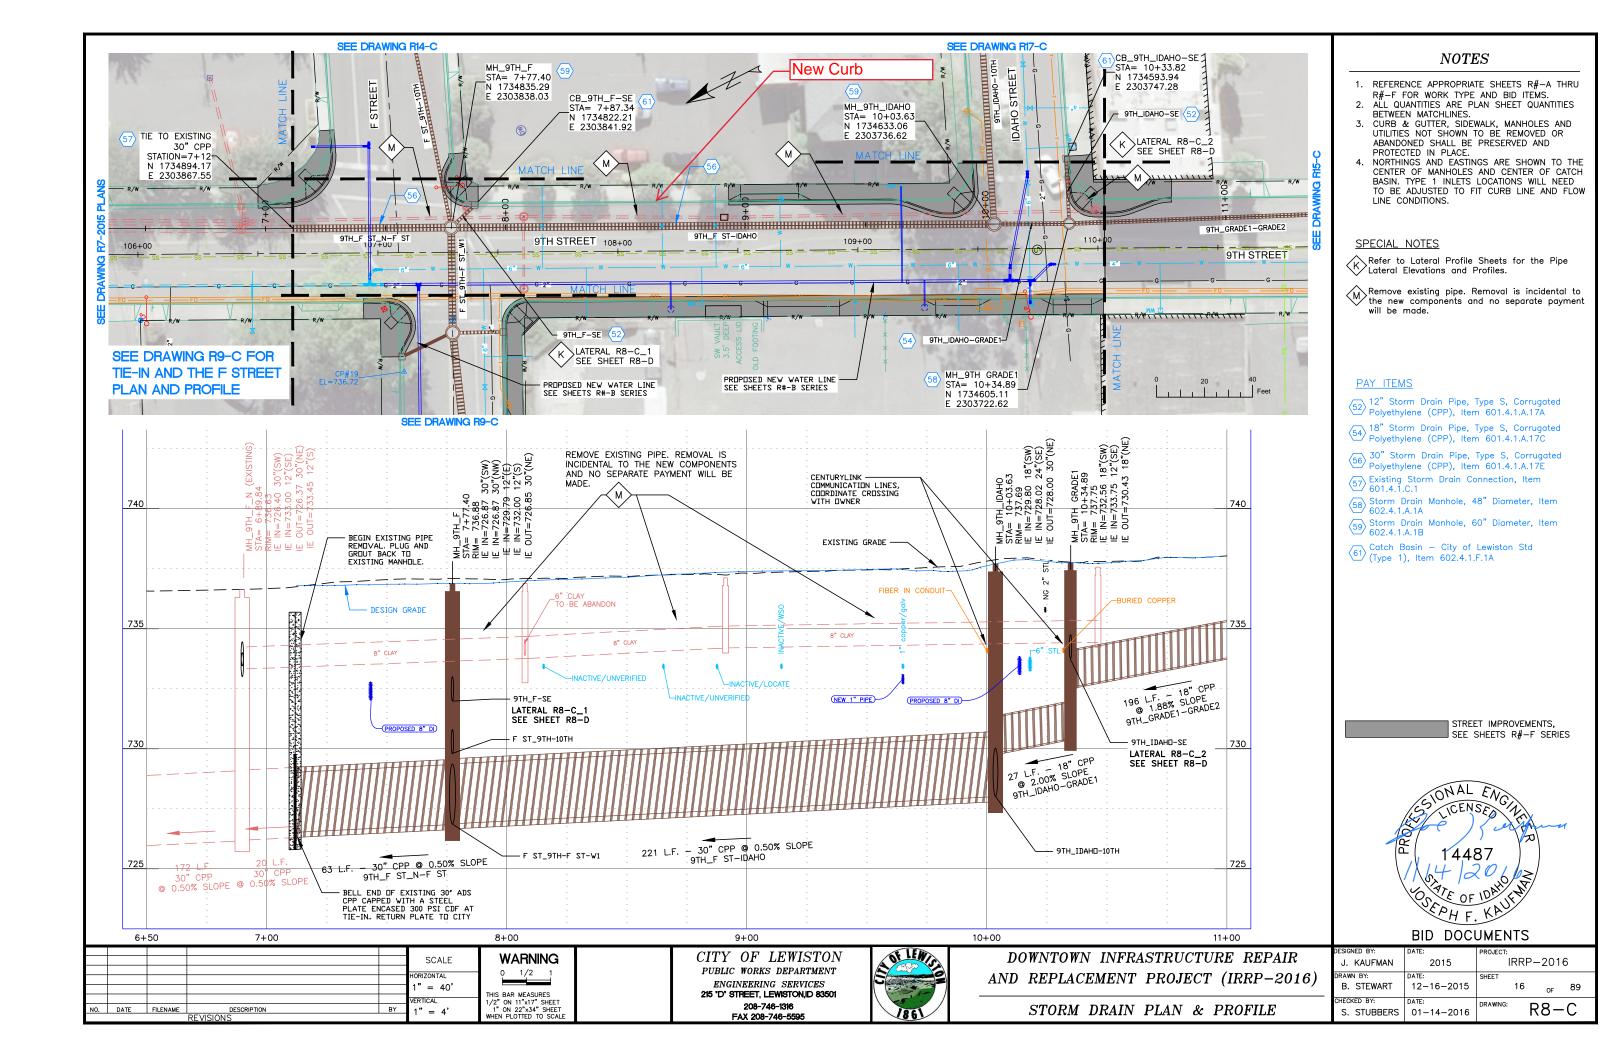

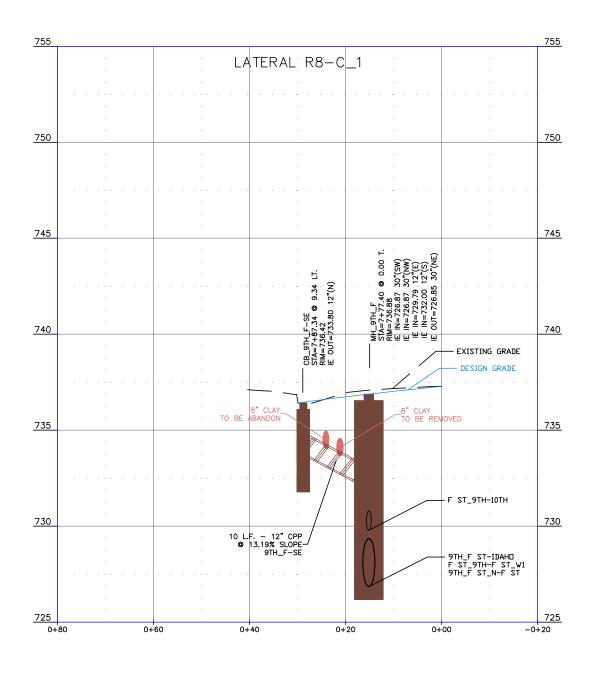

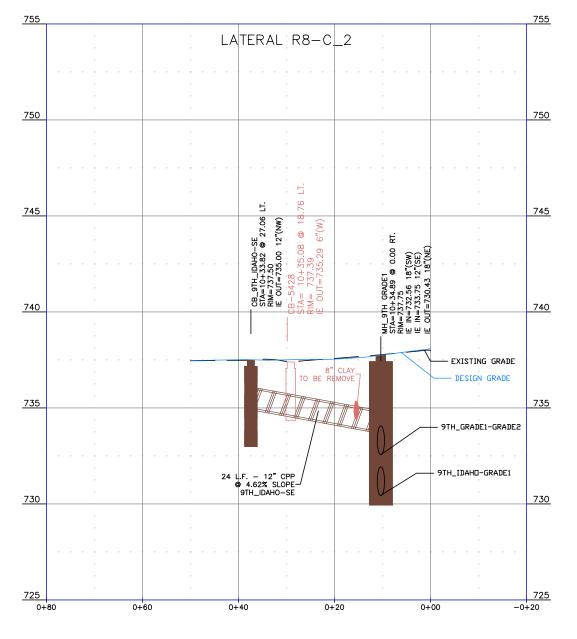

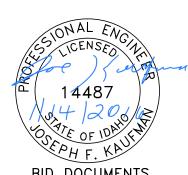

BID DOCUMENTS

WARNING SCALE 0 1/2 1 AS SHOWN THIS BAR MEASURES 1/2" ON 11"x17" SHEET 1" ON 22"x34" SHEET WHEN PLOTTED TO SCALE VERTICAL AS SHOWN


CITY OF LEWISTON PUBLIC WORKS DEPARTMENT ENGINEERING SERVICES 215 'D' STREET, LEWISTON, ID 83501 208-746-1316 FAX 208-746-5595




DOWNTOWN INFRASTRUCTURE REPAIR AND REPLACEMENT PROJECT (IRRP-2016)

STORM D	RAIN LATE	RAL PROFI	LES
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	212 200	011121110
DESIGNED BY:	DATE:	PROJECT:
J. KAUFMAN	2015	IRRP-2016
DRAWN BY:	DATE:	SHEET
B. STEWART	12-16-2015	17 _{OF} 89
CHECKED BY:	DATE:	DRAWING: DO D
S. STUBBERS	01-14-2016	R8-D



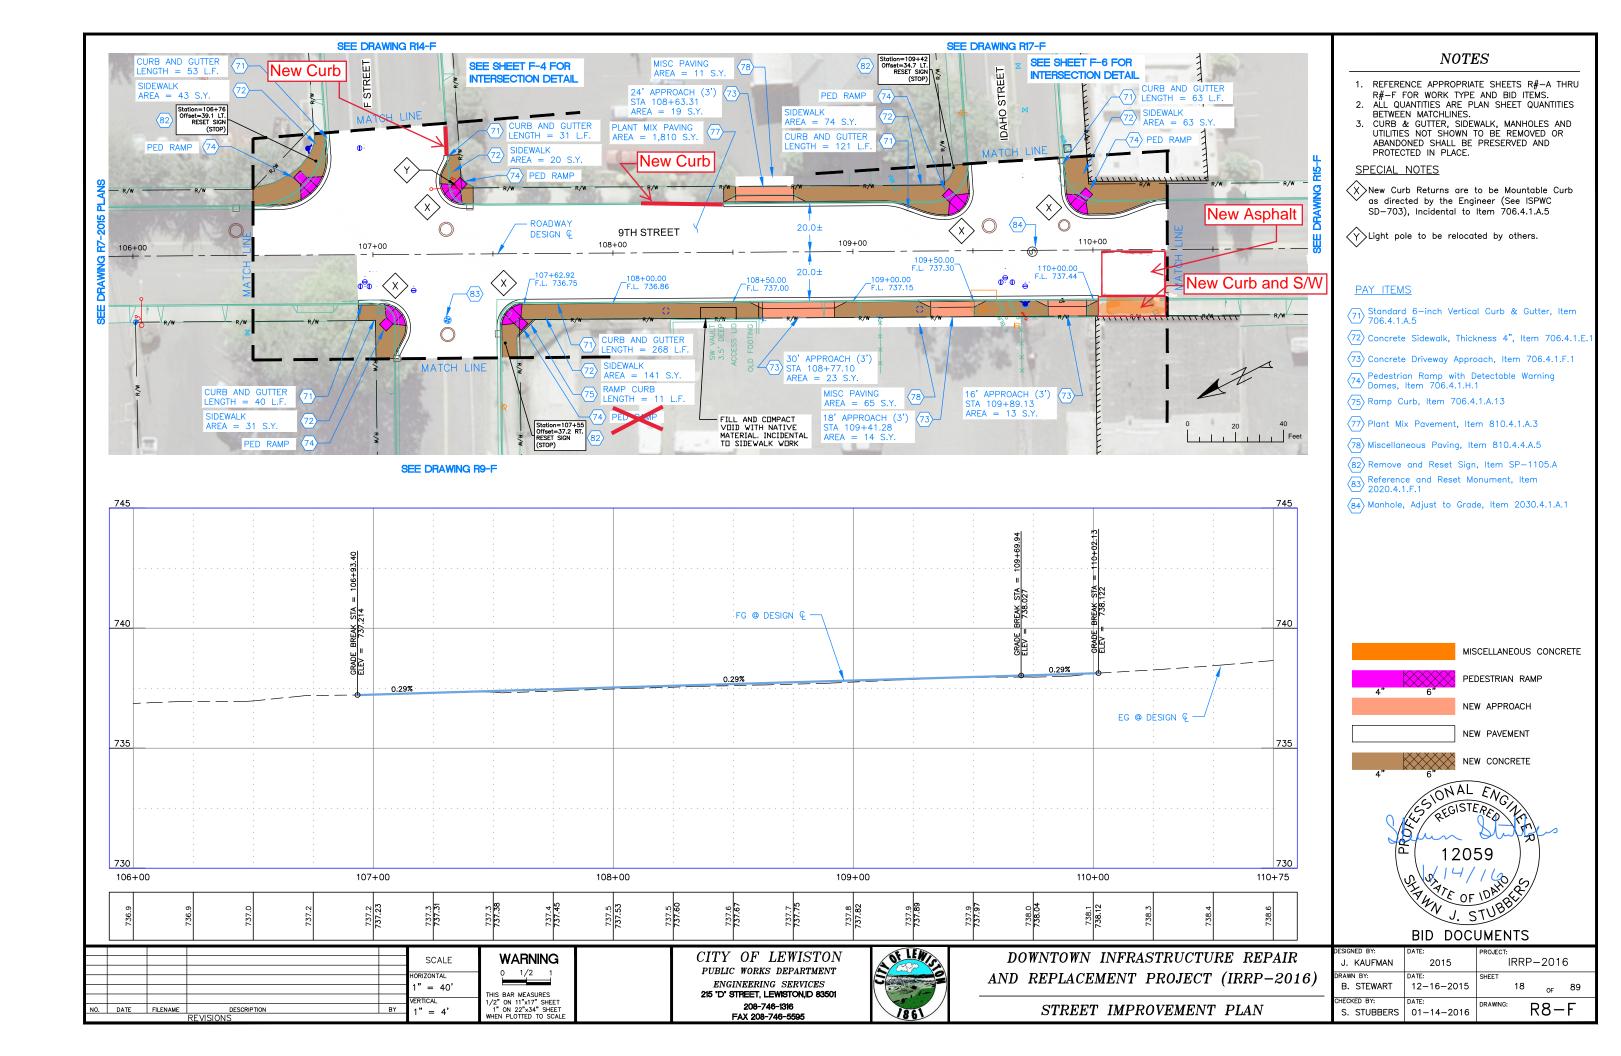

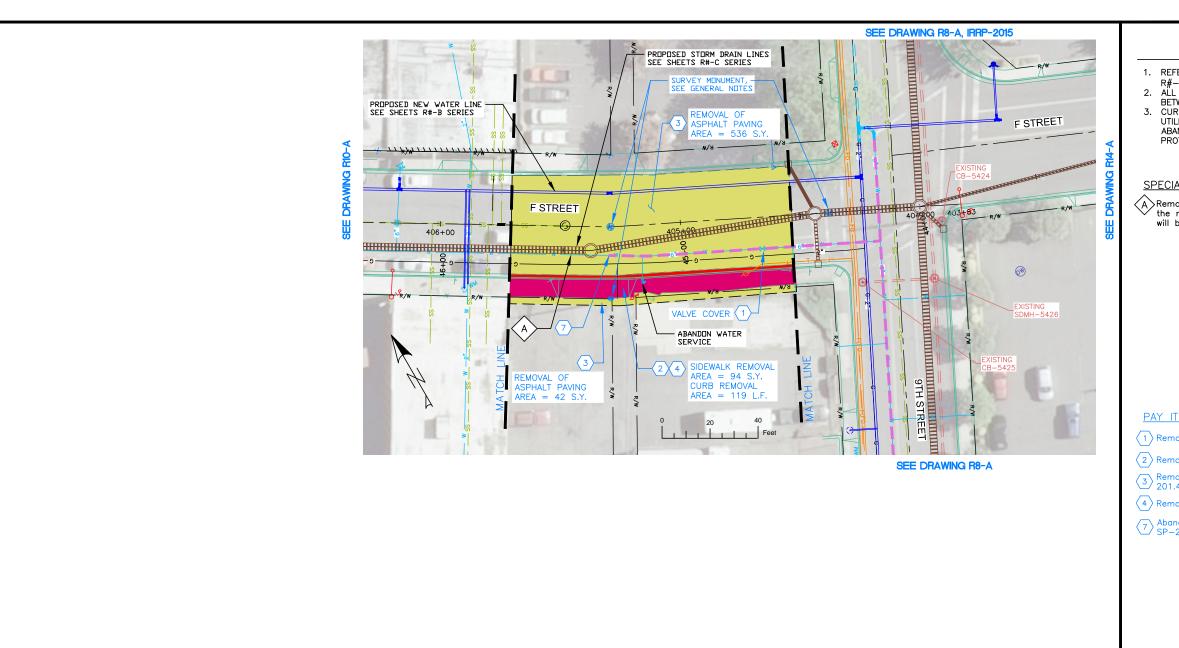NOTES

- REFERENCE APPROPRIATE SHEETS R#-A THRU R#-F FOR WORK TYPE AND BID ITEMS.


 2. ALL QUANTITIES ARE PLAN SHEET QUANTITIES BETWEEN MATCHLINES.
- 3. CURB & GUTTER, SIDEWALK, MANHOLES AND UTILITIES NOT SHOWN TO BE REMOVED OR ABANDONED SHALL BE PRESERVED AND PROTECTED IN PLACE.

SPECIAL NOTES

Remove existing pipe. Removal is incidental to the new components and no separate payment will be made.

PAY ITEMS

- 1 Removal of Obstruction, Ea., Item 201.4.1.C.1
- 2 Removal of Sidewalk, Item 201.4.1.D.1A
- $\begin{tabular}{ll} \hline 3 & Removal of Bituminous Surface, Item \\ 201.4.1.D.1B \end{tabular}$
- 4 Removal of Curb, Item 201.4.1.E.1
- 7 Abandon Pipe In Place, (Plug End), Item SP-201.A

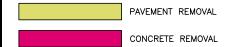



BID DOCUMENTS

SCALE 1" = 40' VERTICAL NO. DATE FILENAME 1" = 4'


WARNING 0 1/2 1 THIS BAR MEASURES
1/2" ON 11"x17" SHEET
1" ON 22"x34" SHEET
WHEN PLOTTED TO SCALE CITY OF LEWISTON PUBLIC WORKS DEPARTMENT ENGINEERING SERVICES
215 "D" STREET, LEWISTON,ID 83501 208-746-1316 FAX 208-746-5595





DOWNTOWN INFRASTRUCTURE REPAIR AND REPLACEMENT PROJECT (IRRP-2016)

REMOVAL PLAN

DESIGNED BY:	DATE:	PROJECT:
J. KAUFMAN	2015	IRRP-2016
DRAWN BY:	DATE:	SHEET
B. STEWART	12-16-2015	19 _{OF} 89
CHECKED BY:	DATE:	DRAWING: DO A
S. STUBBERS	01-14-2016	R9-A

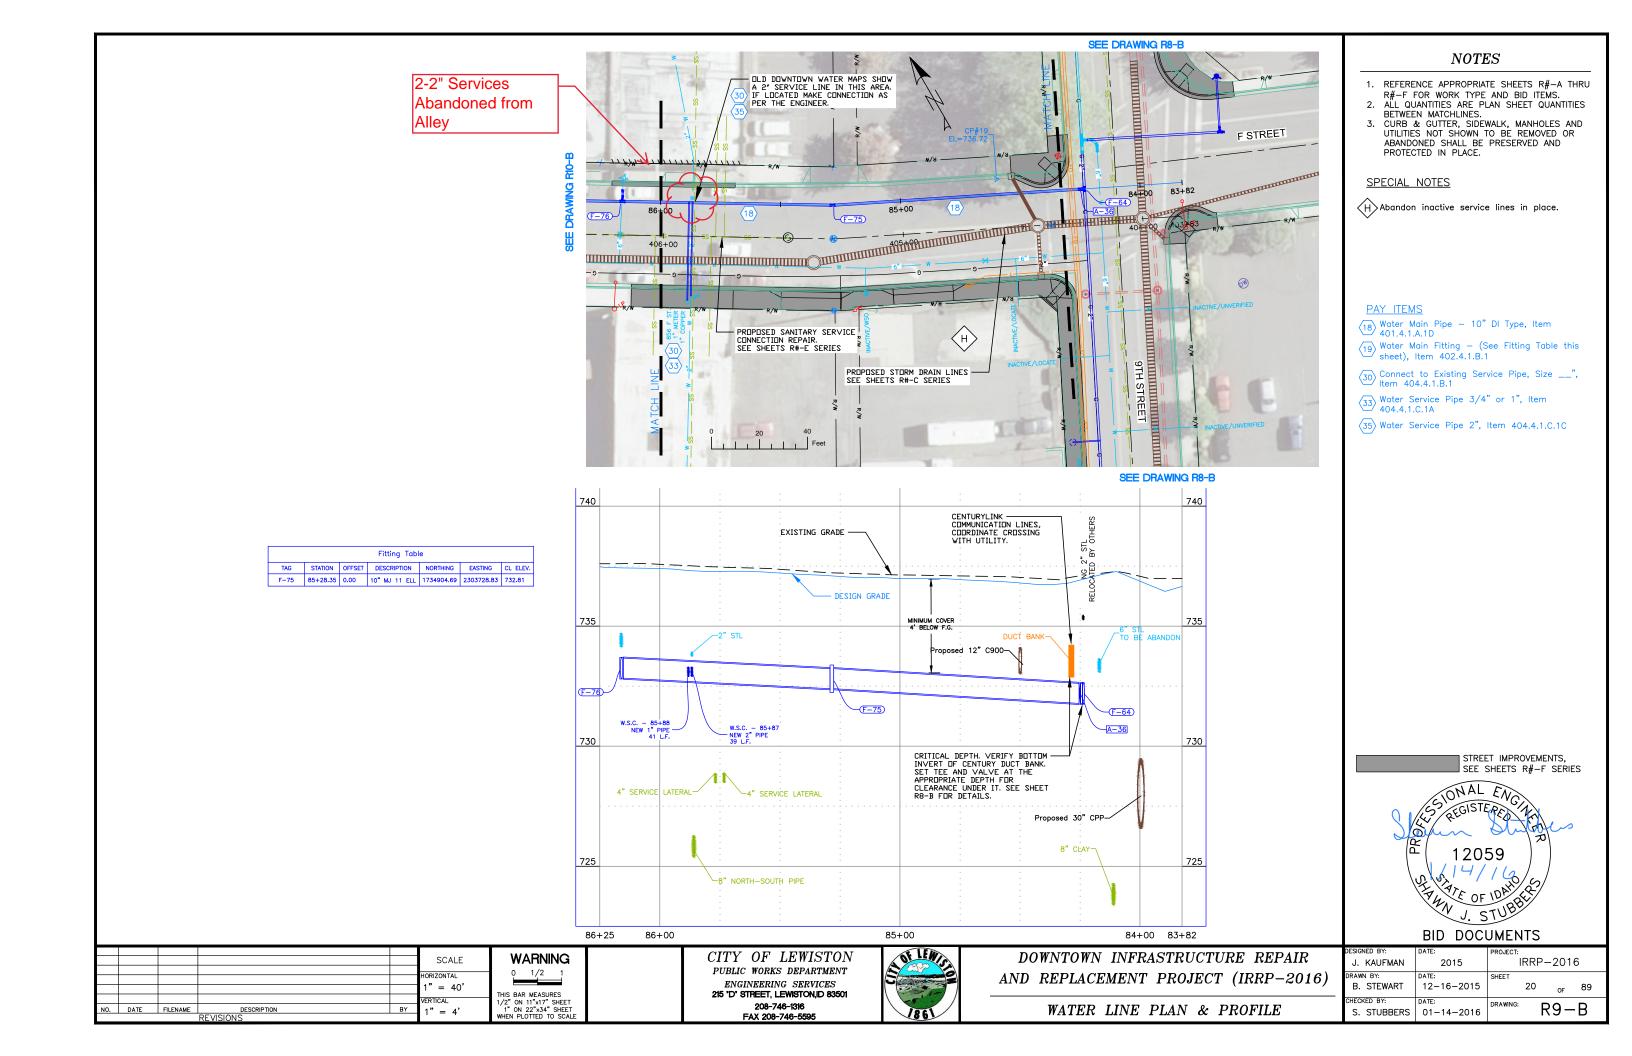

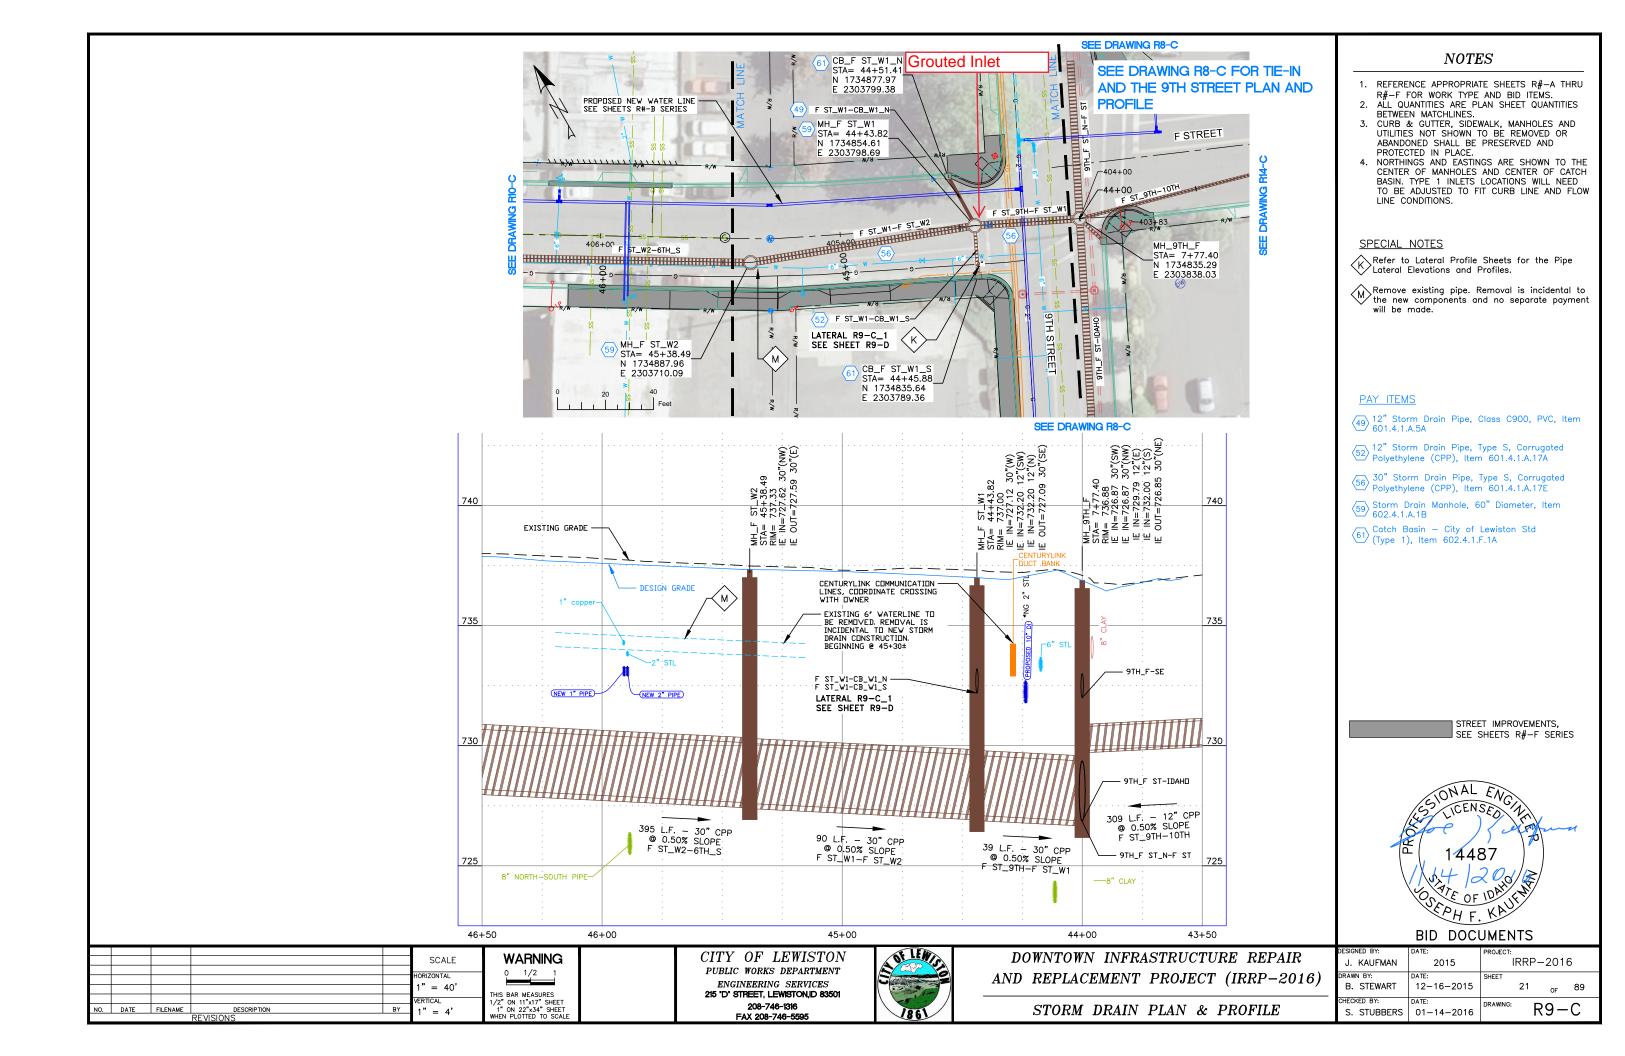

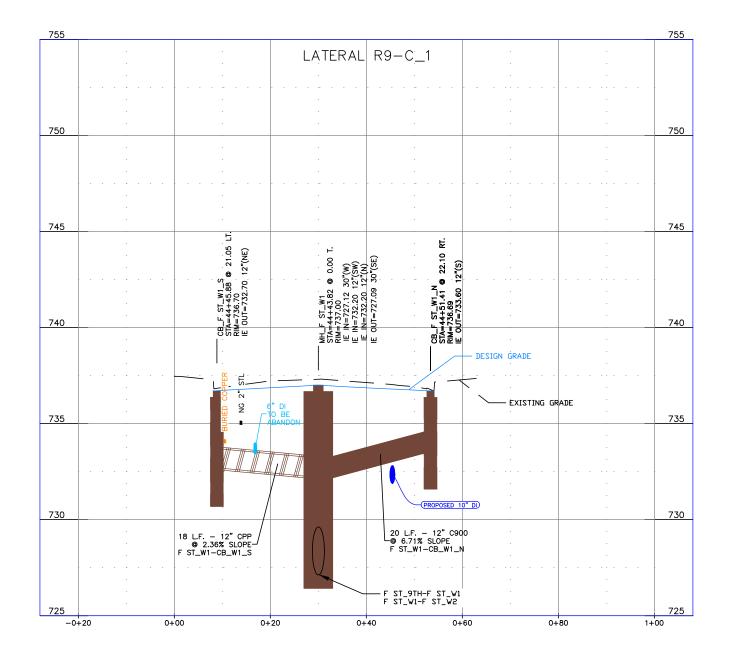



WARNING SCALE 0 1/2 1 AS SHOWN THIS BAR MEASURES
1/2" ON 11"x17" SHEET
1" ON 22"x34" SHEET
WHEN PLOTTED TO SCALE VERTICAL

AS SHOWN


CITY OF LEWISTON PUBLIC WORKS DEPARTMENT ENGINEERING SERVICES 215 'D' STREET, LEWISTON, ID 83501 208-746-1316 FAX 208-746-5595





DOWNTOWN INFRASTRUCTURE REPAIR AND REPLACEMENT PROJECT (IRRP-2016)


STORM DRAIN LATERAL PROFILES


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	J. KAUFMAN	2015	IRRP-2016
	DRAWN BY:	DATE:	SHEET
	B. STEWART	12-16-2015	22 _{OF} 89
	CHECKED BY:	DATE:	DRAWING: DO D
	S. STUBBERS	01-14-2016	R9-D

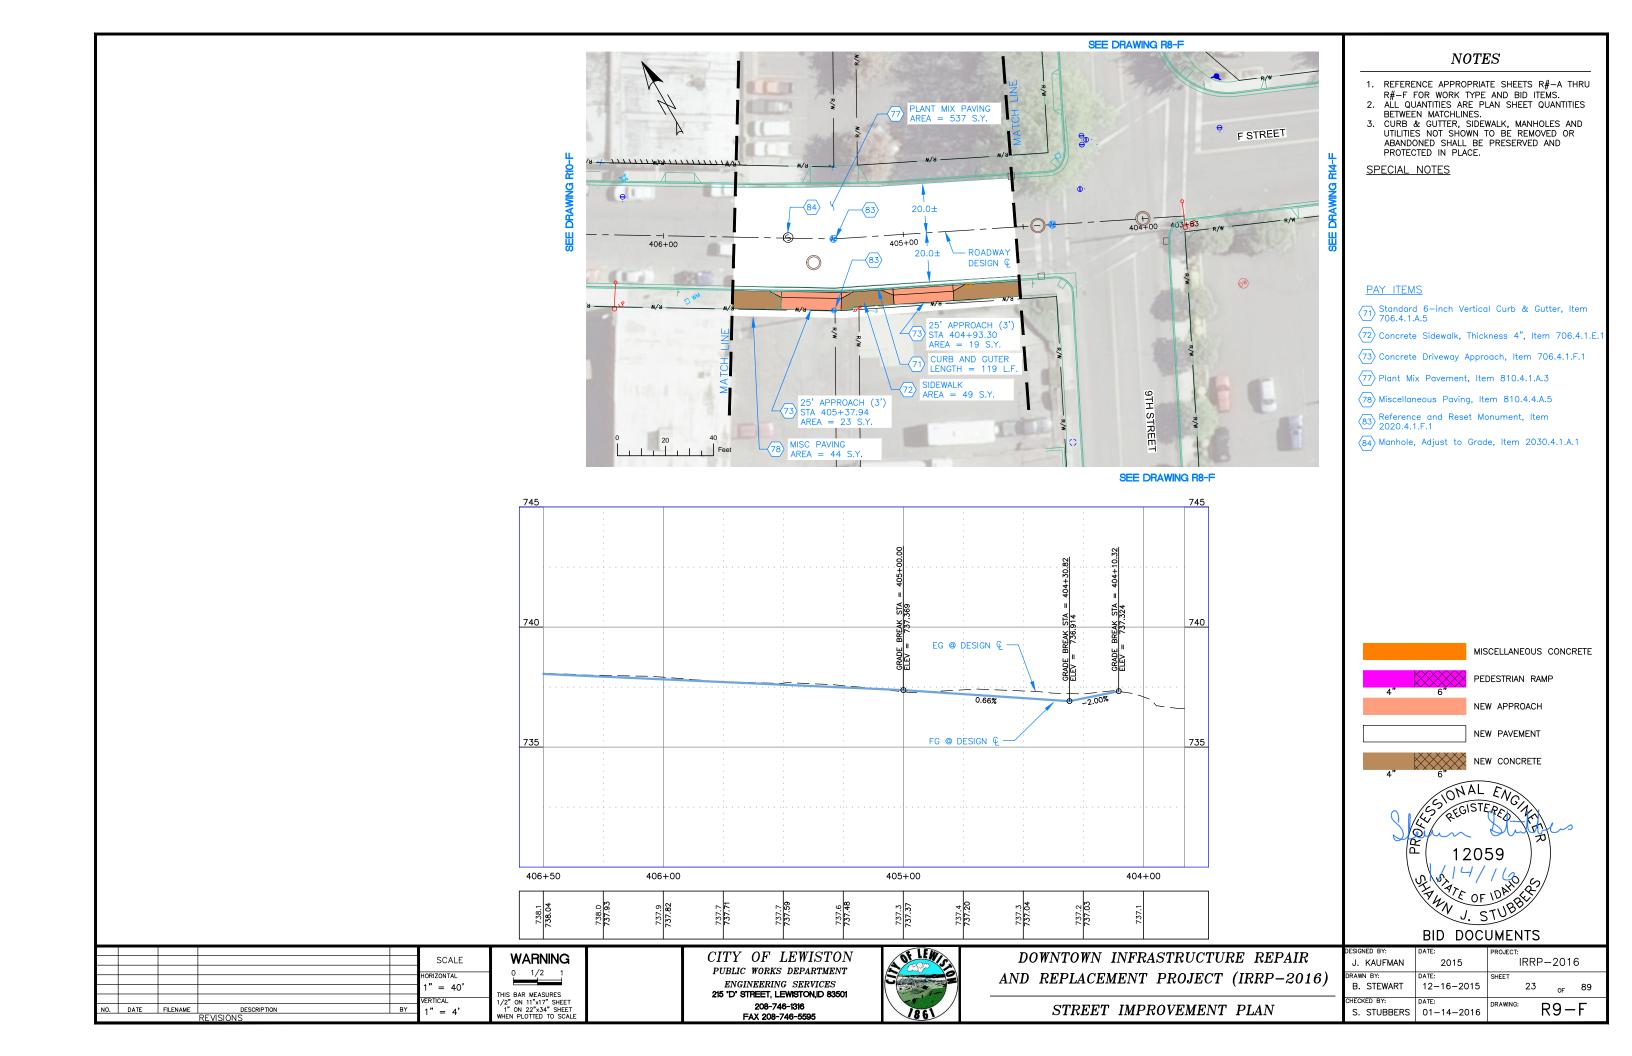


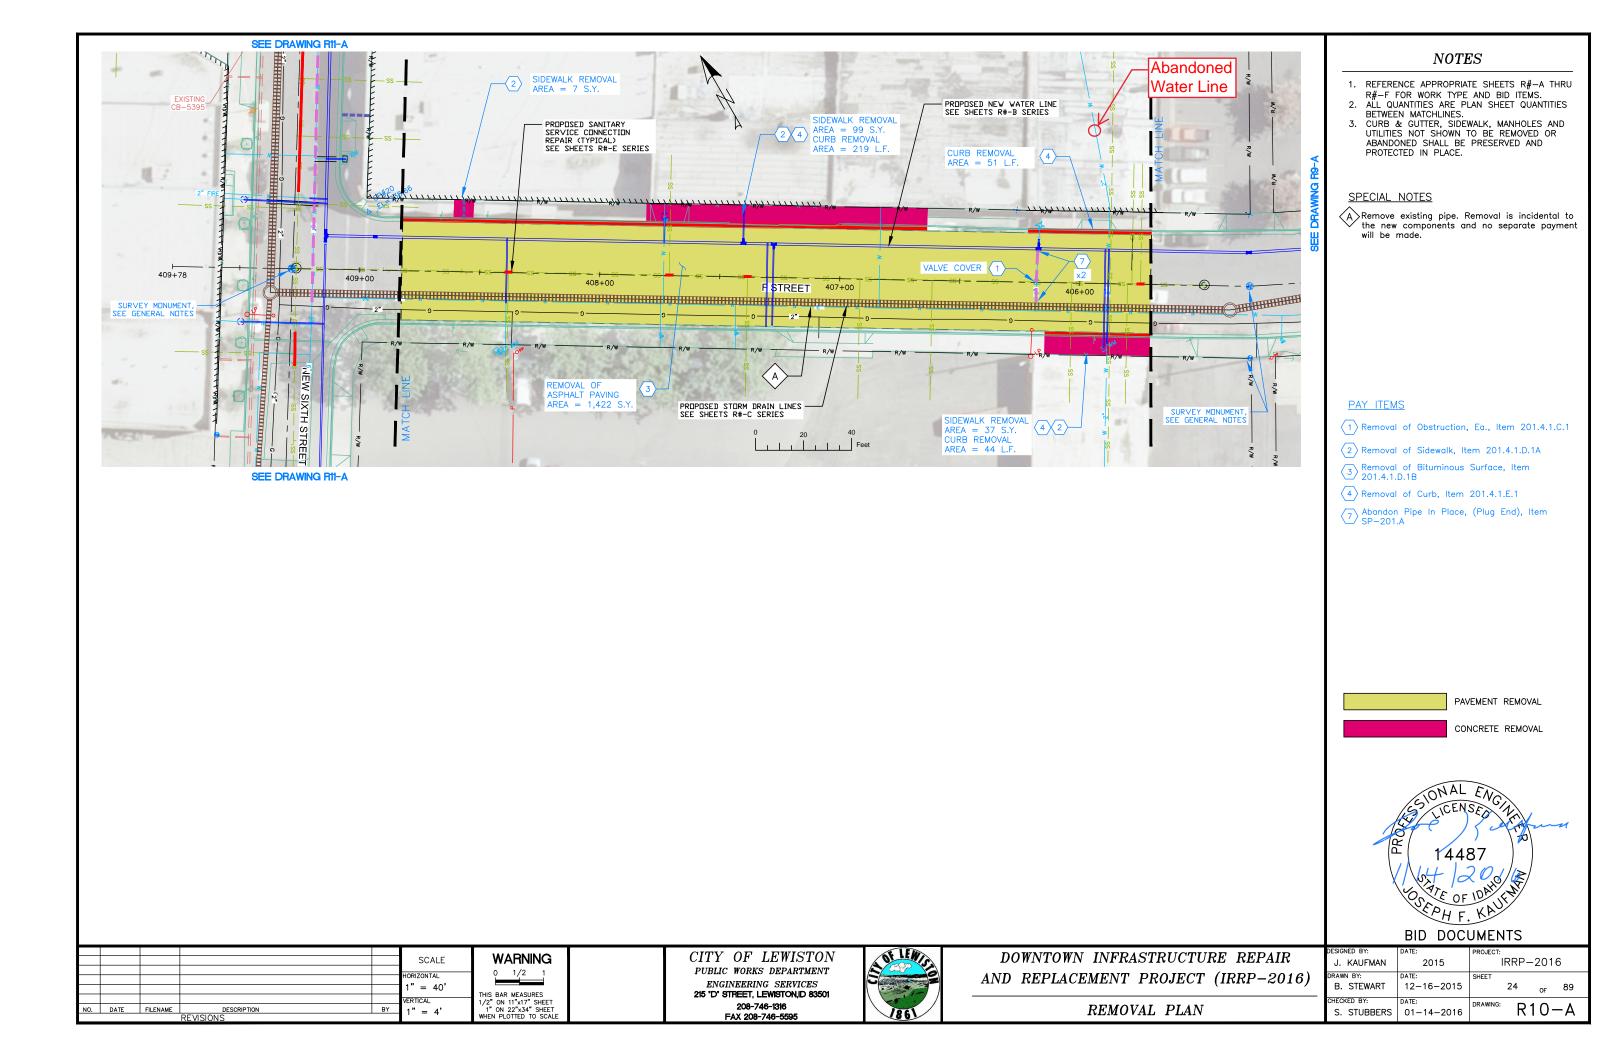


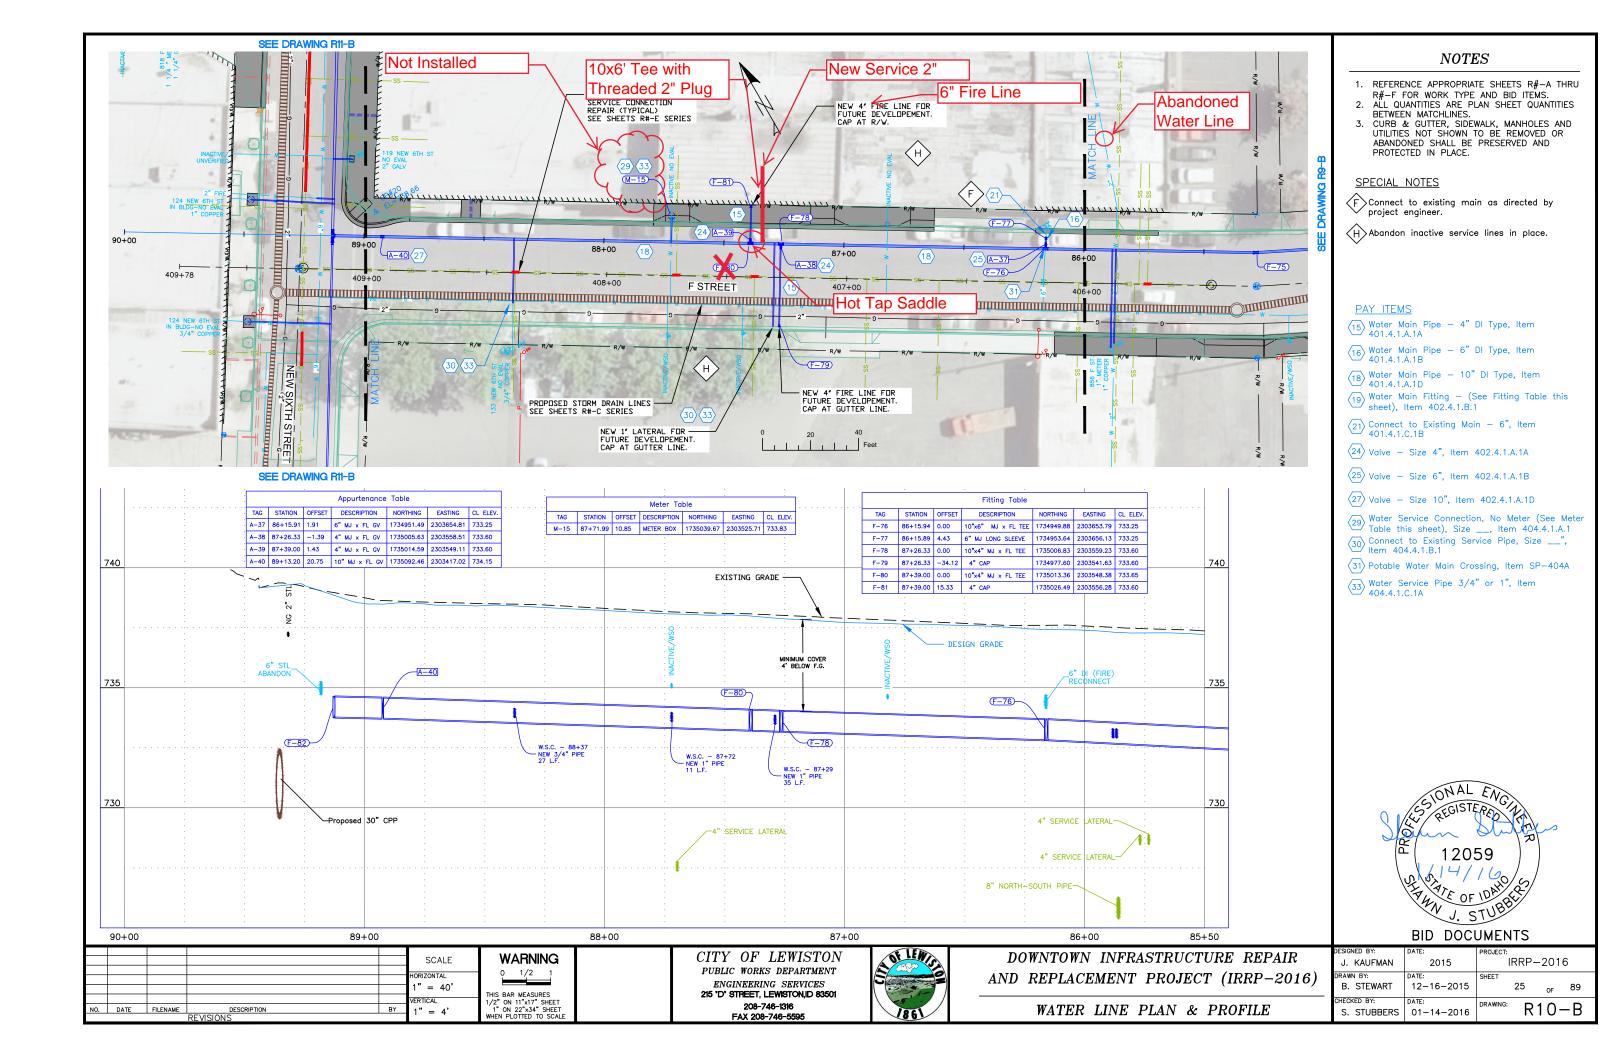


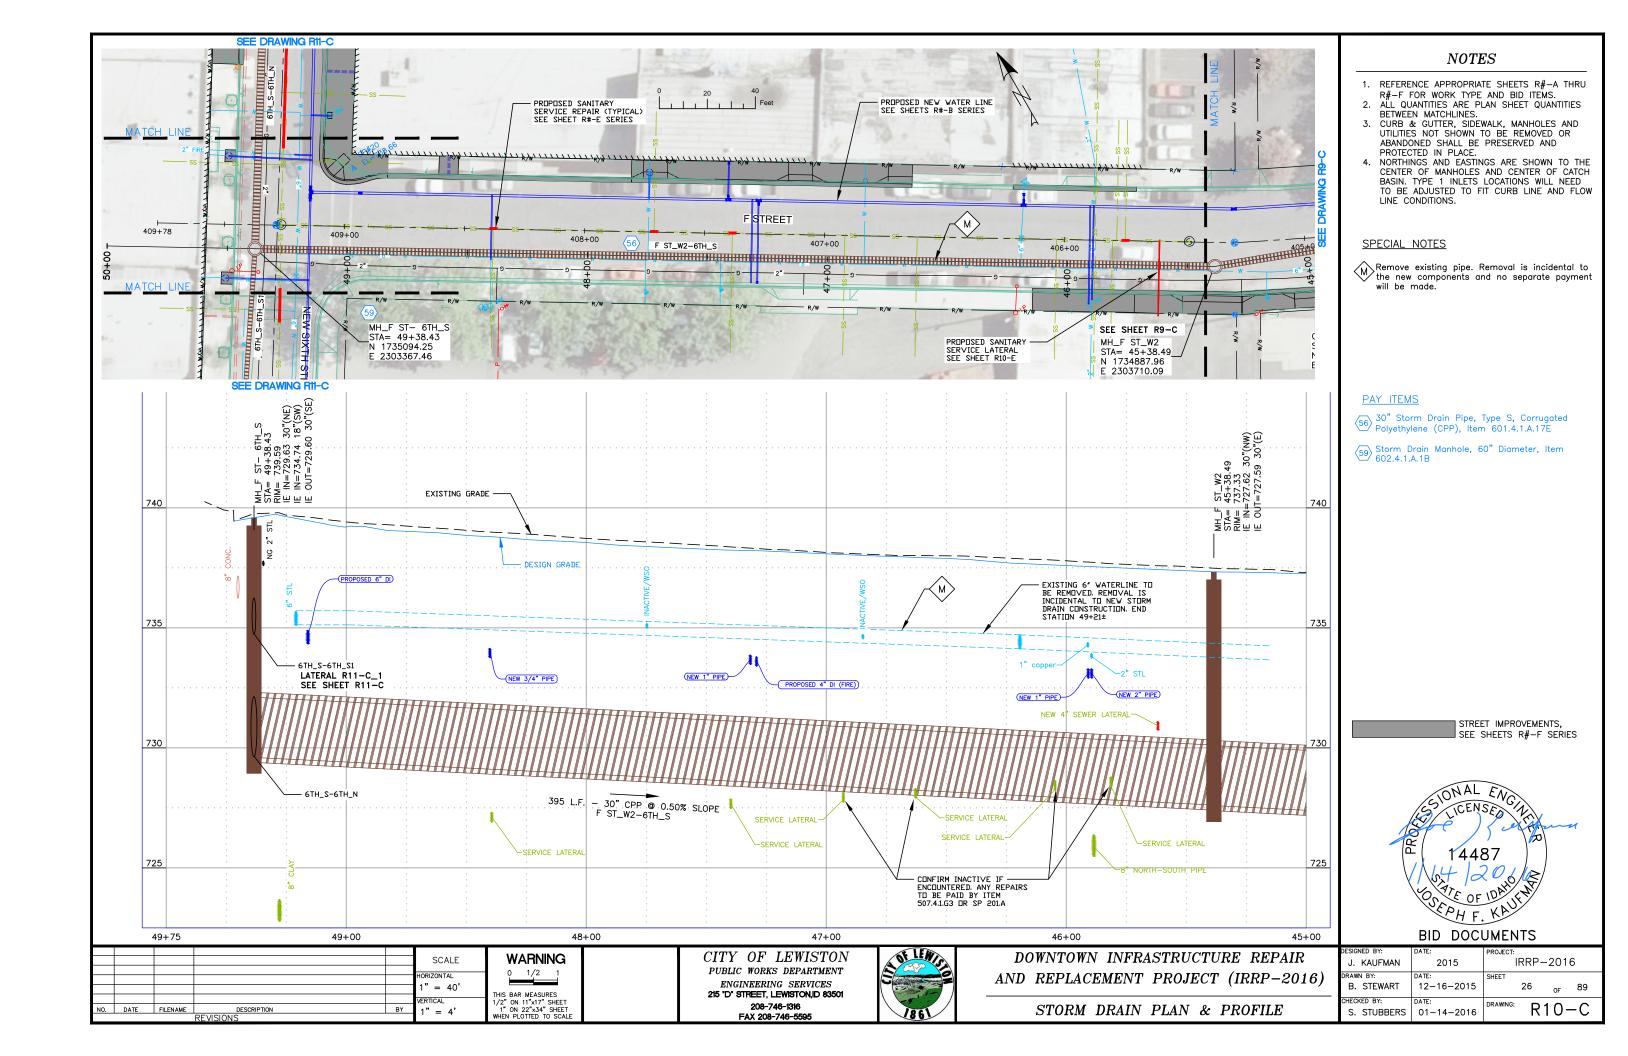


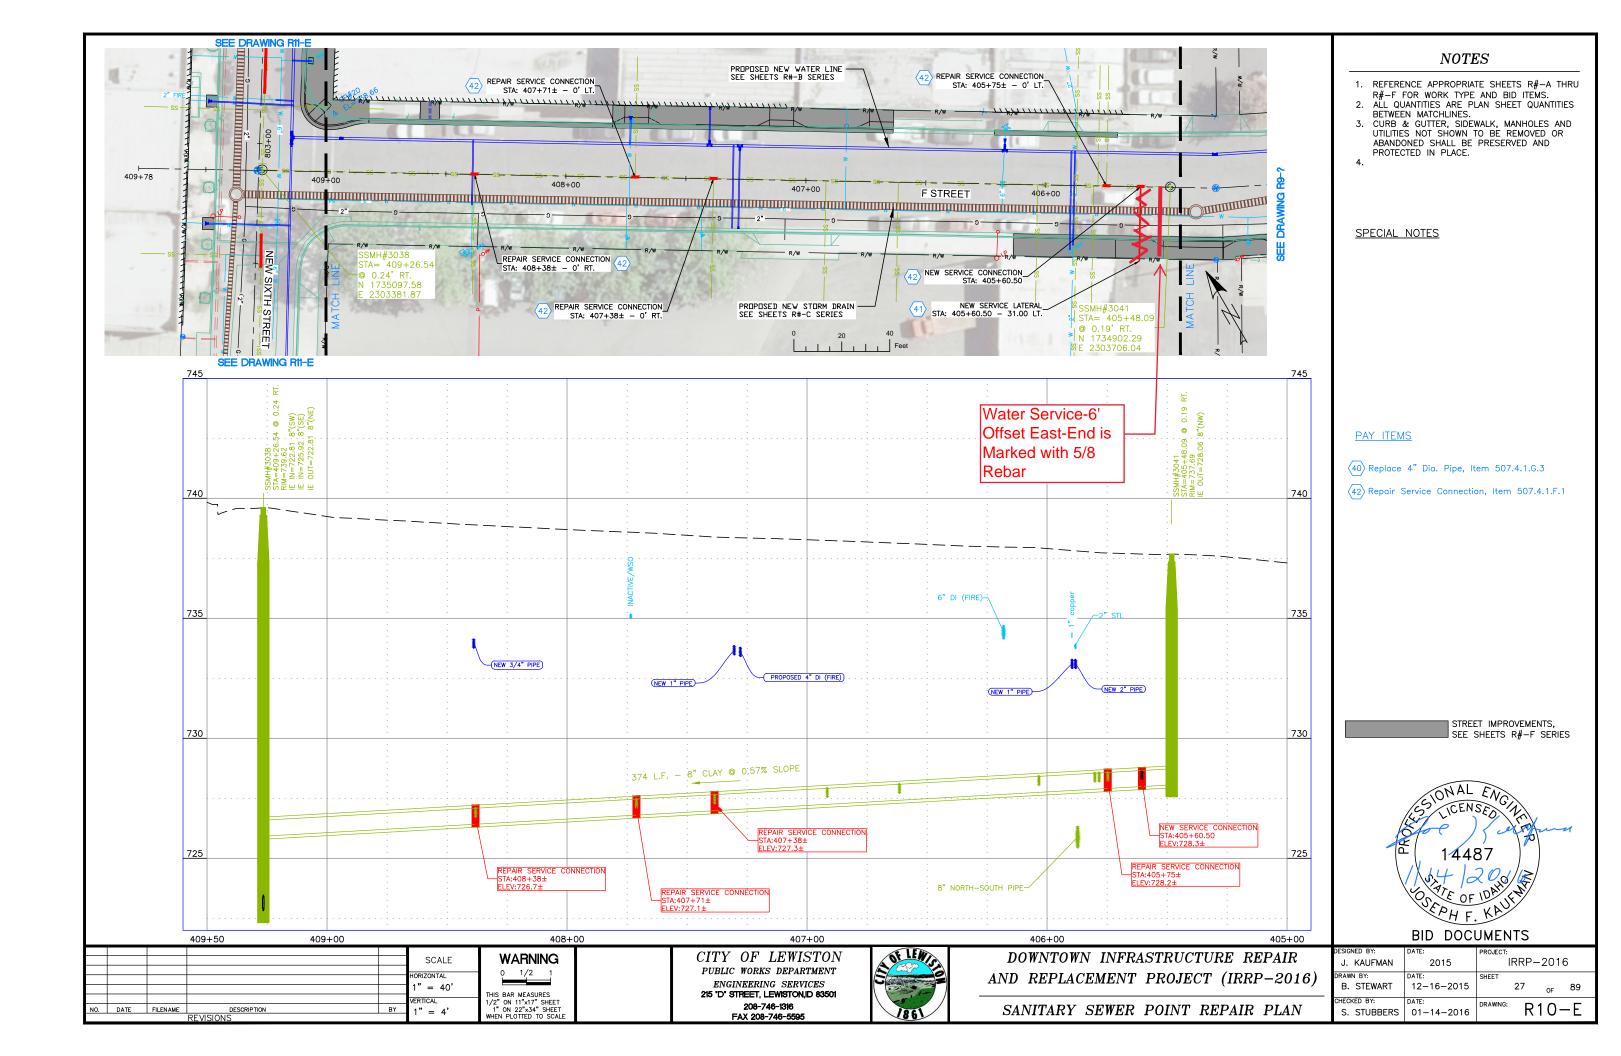


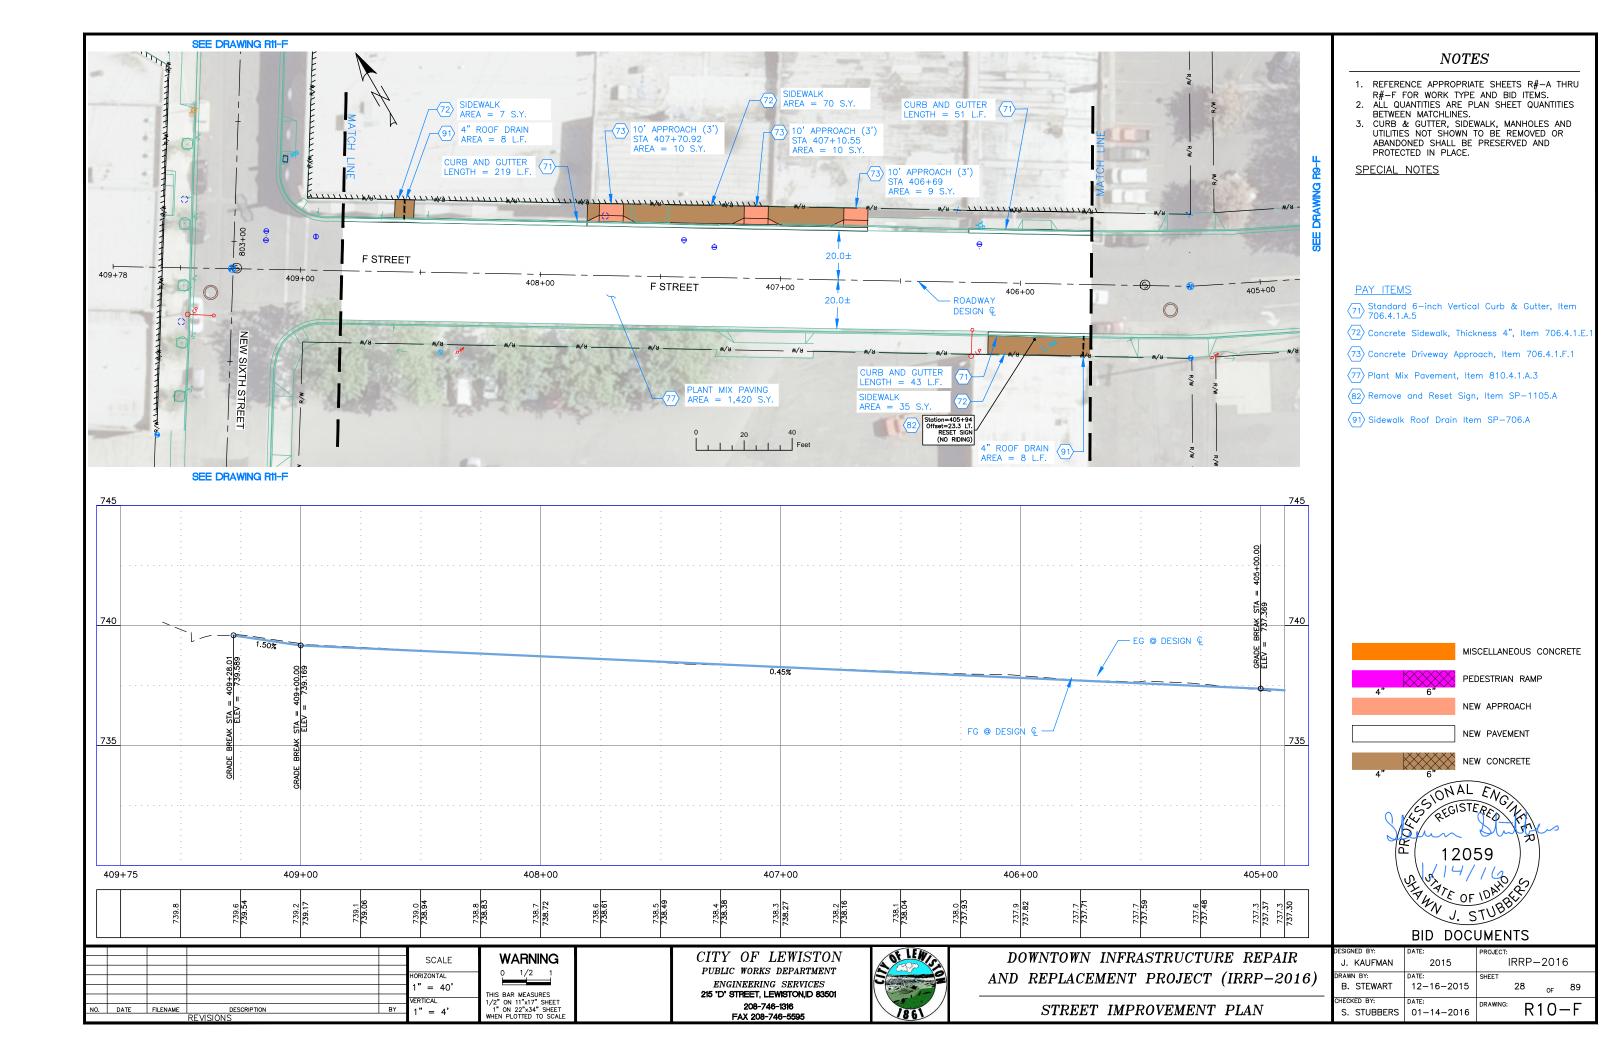

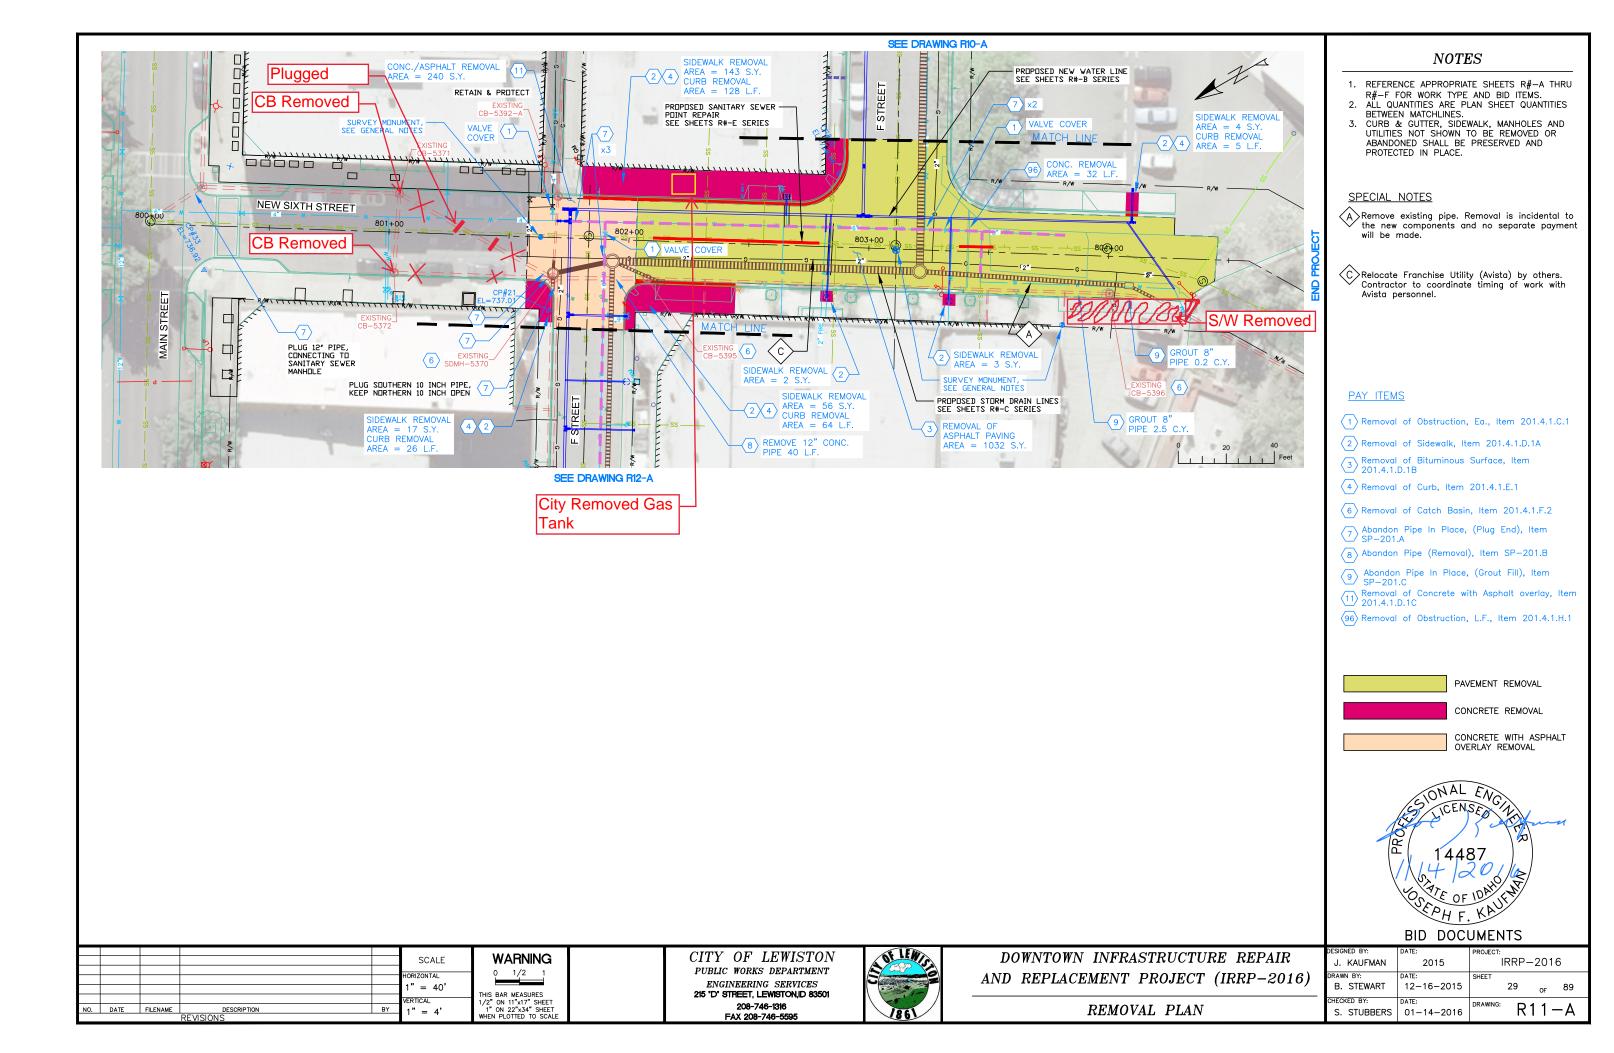

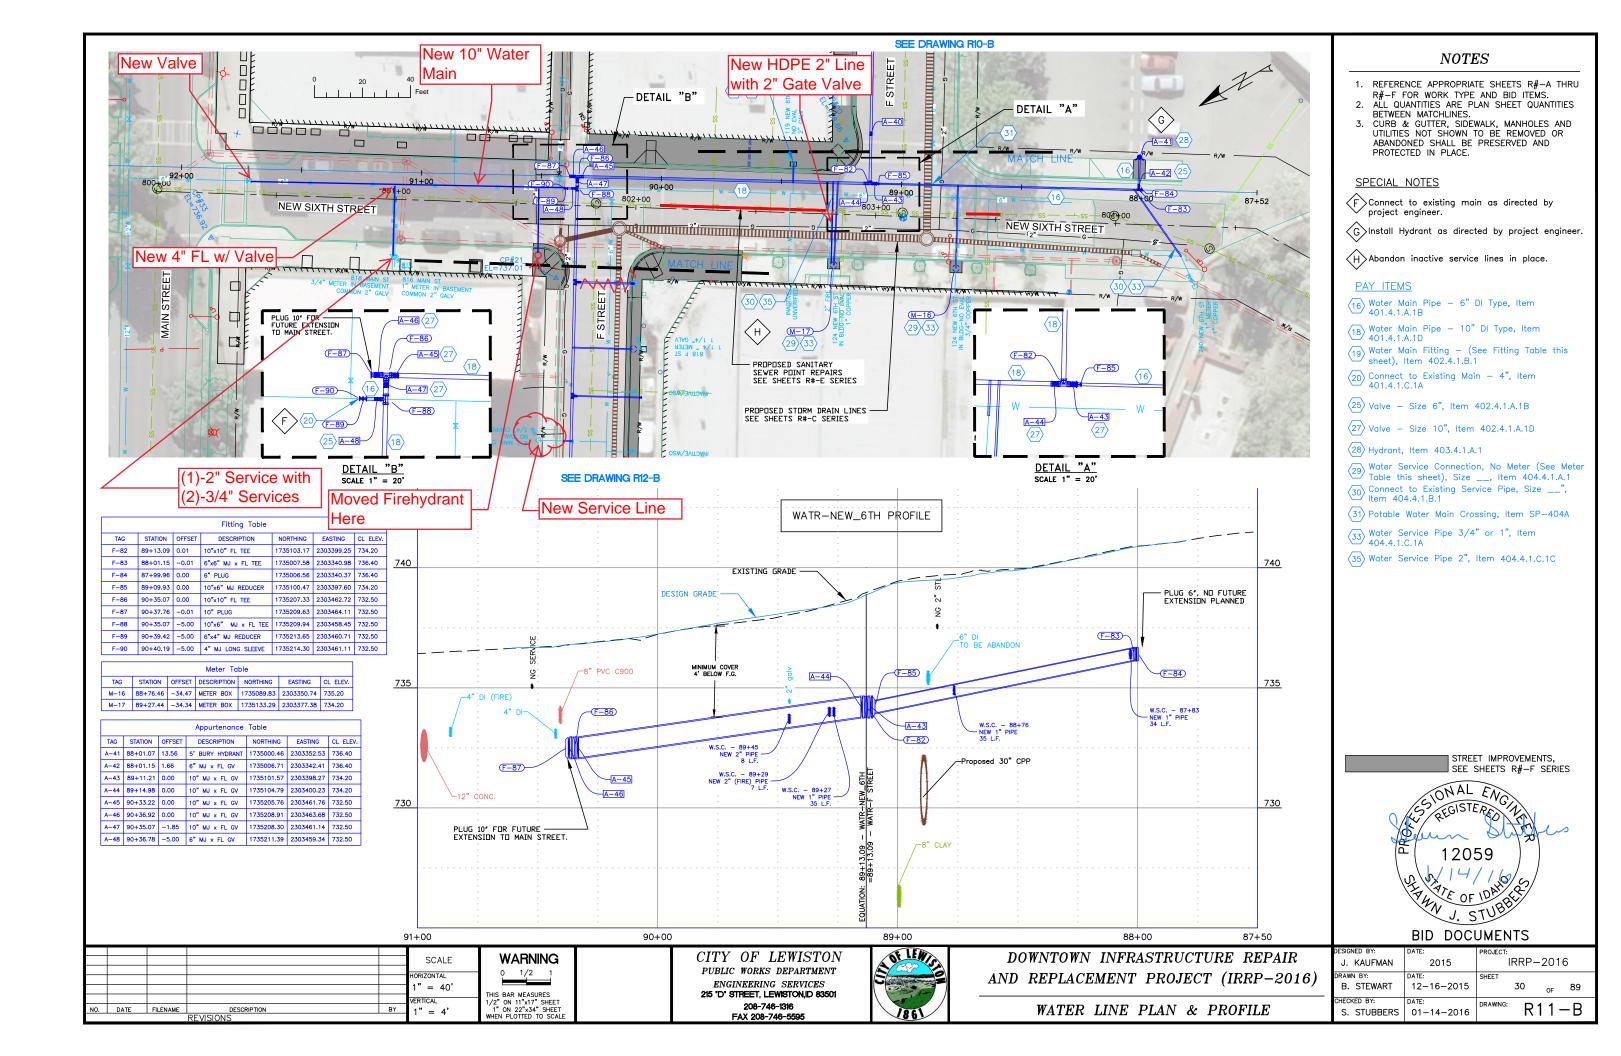

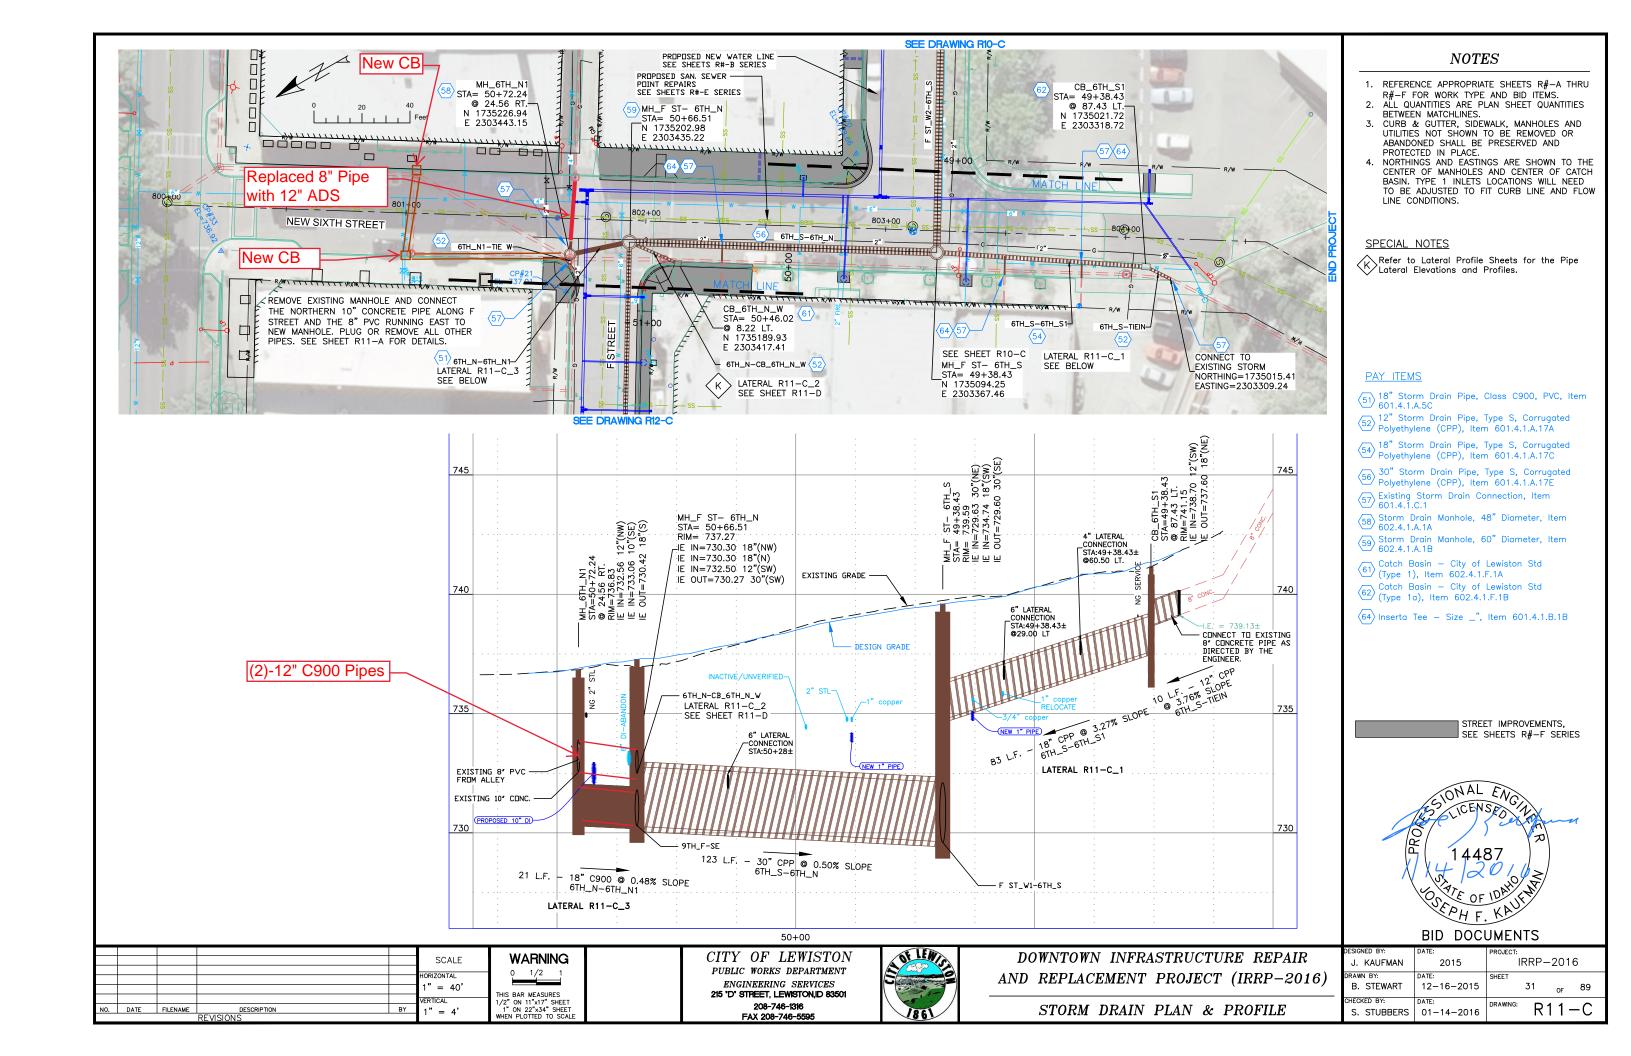

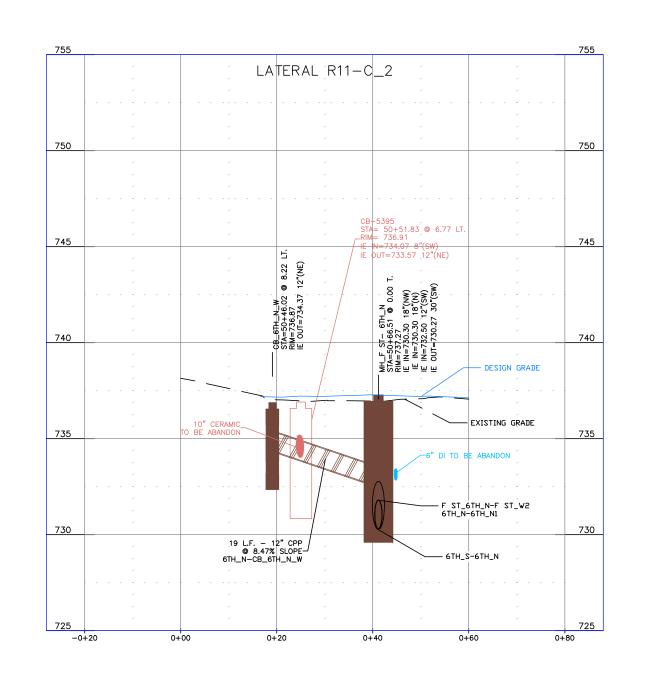



BID DOCUMENTS

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					AS SHOWN
					VERTICAL
					VERTICAL
).	DATE	FILENAME	DESCRIPTION	BY	AS SHOWN
REVISIONS				AS 51101111	

WARNING

0 1/2 1

THIS BAR MEASURES
1/2" ON 11"x17" SHEET
1" ON 22"x34" SHEET
WHEN PLOTTED TO SCALE


CITY OF LEWISTON
PUBLIC WORKS DEPARTMENT
ENGINEERING SERVICES
215 'D' STHEET, LEWISTON, ID 83501
208-746-1316
FAX 208-746-5595





DOWNTOWN INFRASTRUCTURE REPAIR AND REPLACEMENT PROJECT (IRRP-2016)


STORM DRAIN LATERAL PROFILES


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DESIGNED BY:	DATE:	PROJECT:
J. KAUFMAN	2015	IRRP-2016
DRAWN BY:	DATE:	SHEET
B. STEWART	12-16-2015	32 _{OF} 89
CHECKED BY:	DATE:	DRAWING: DA 4 D
S. STUBBERS	01-14-2016	R11-D

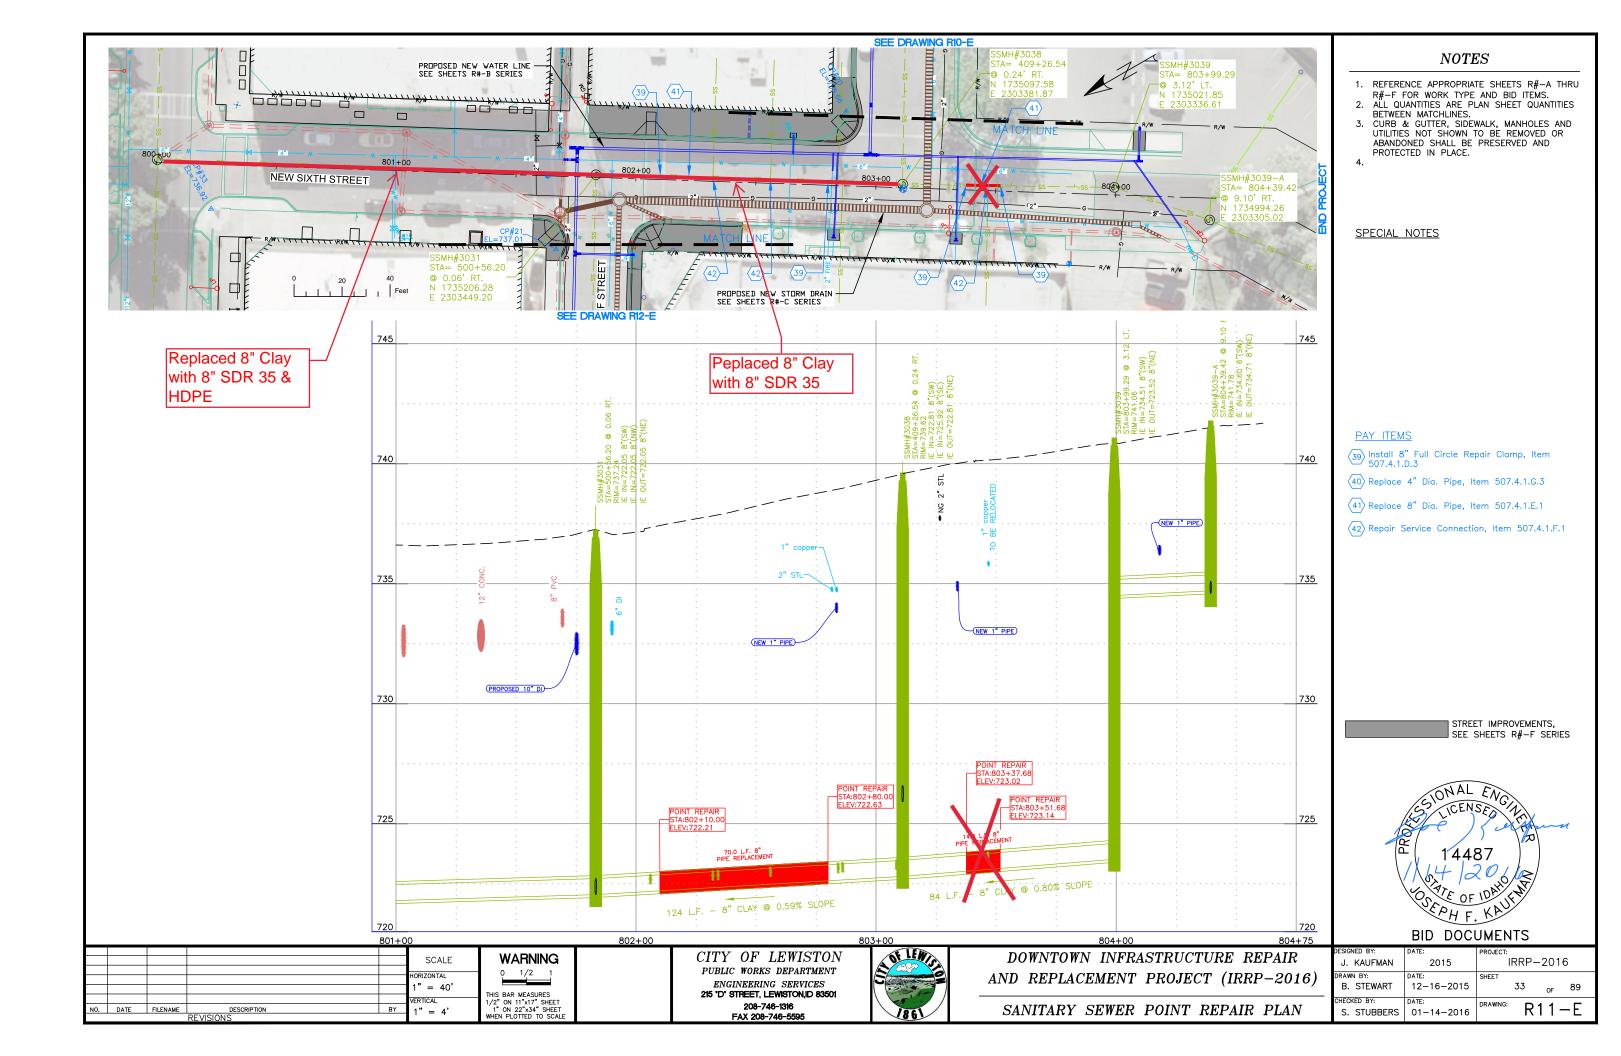


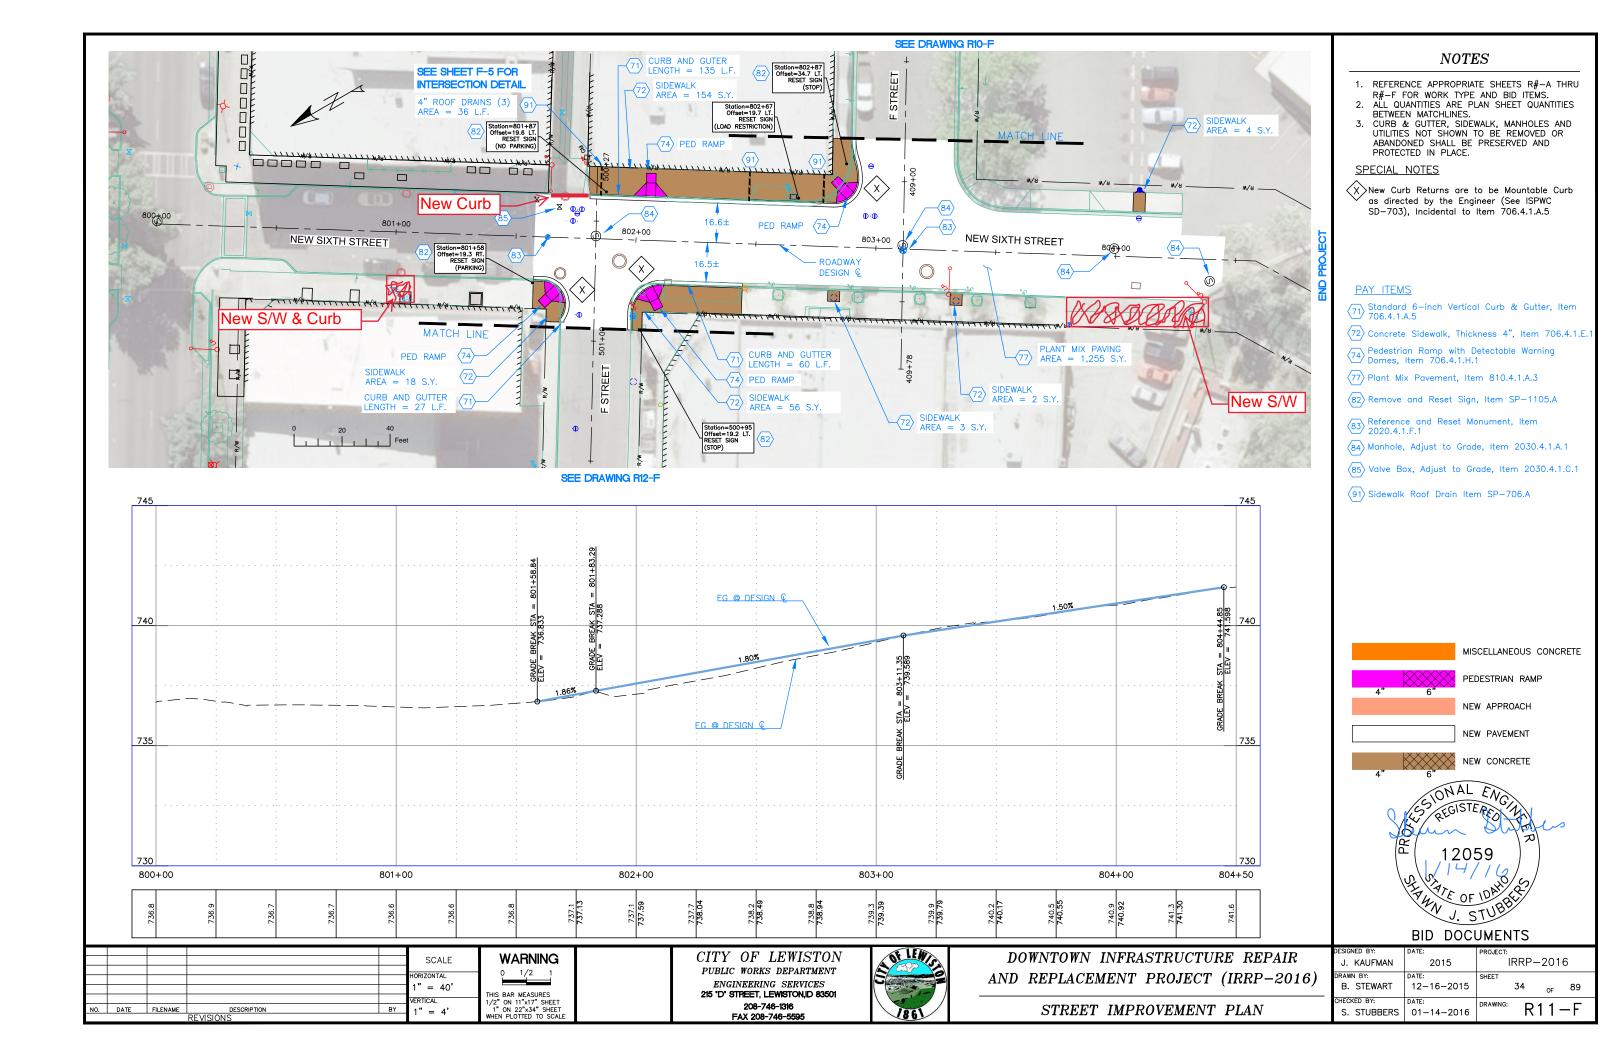


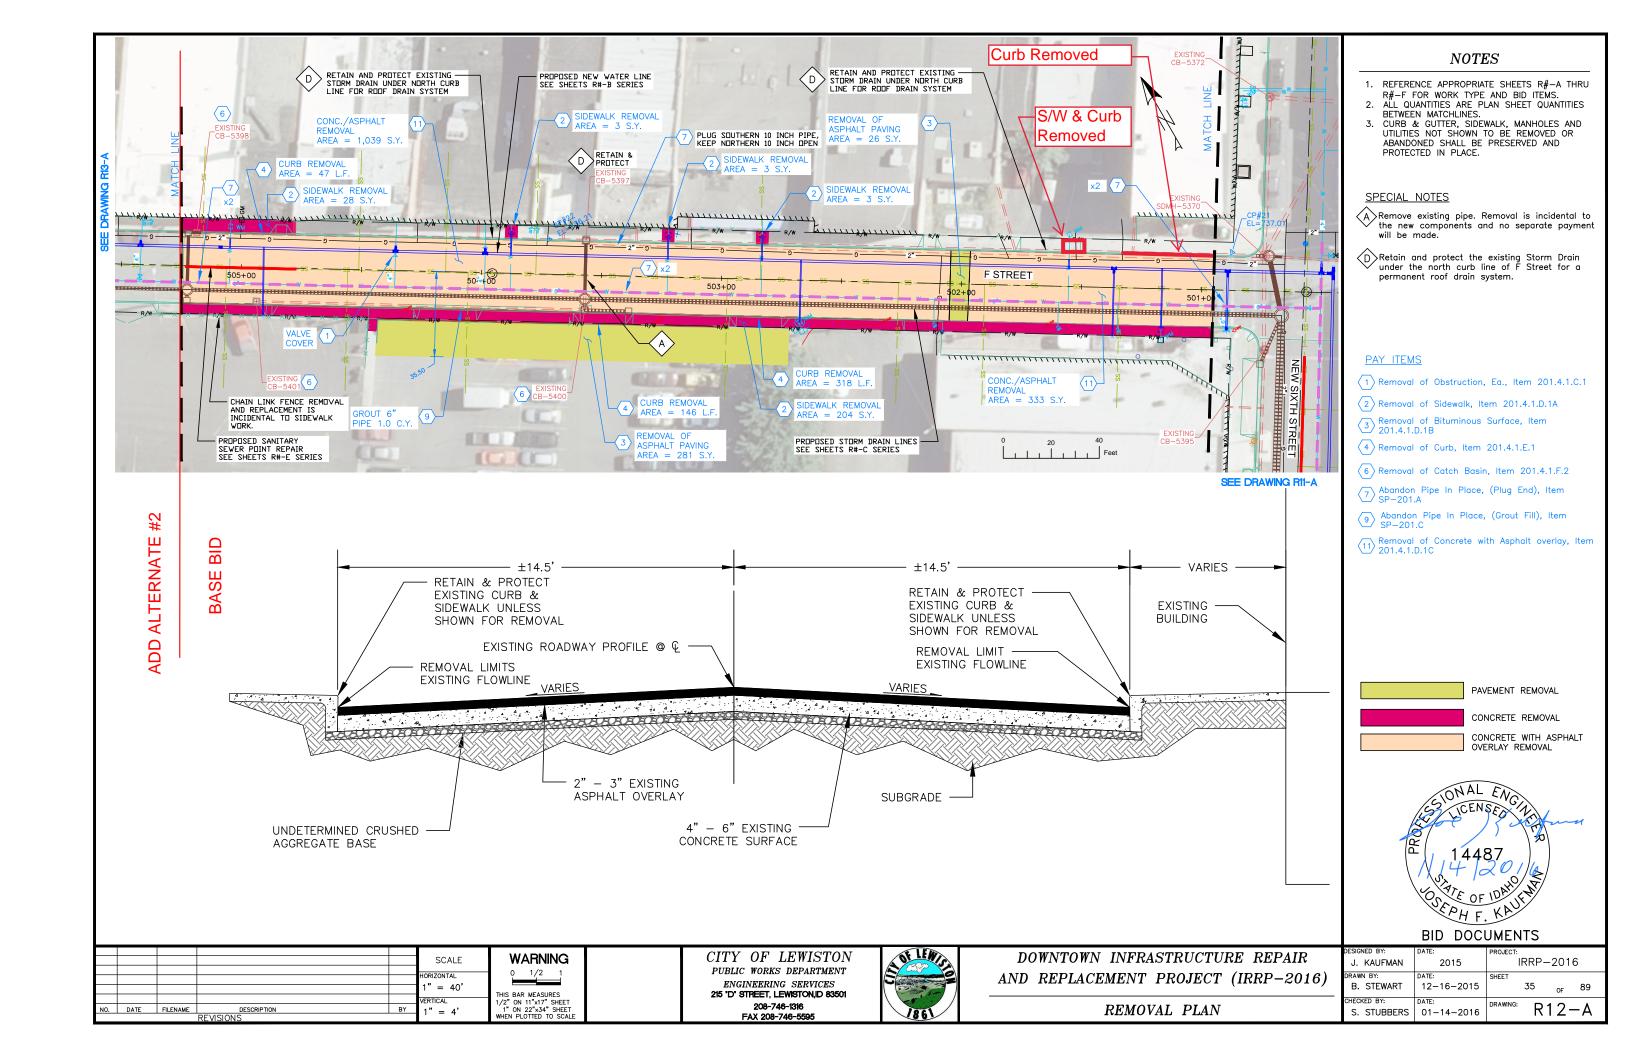

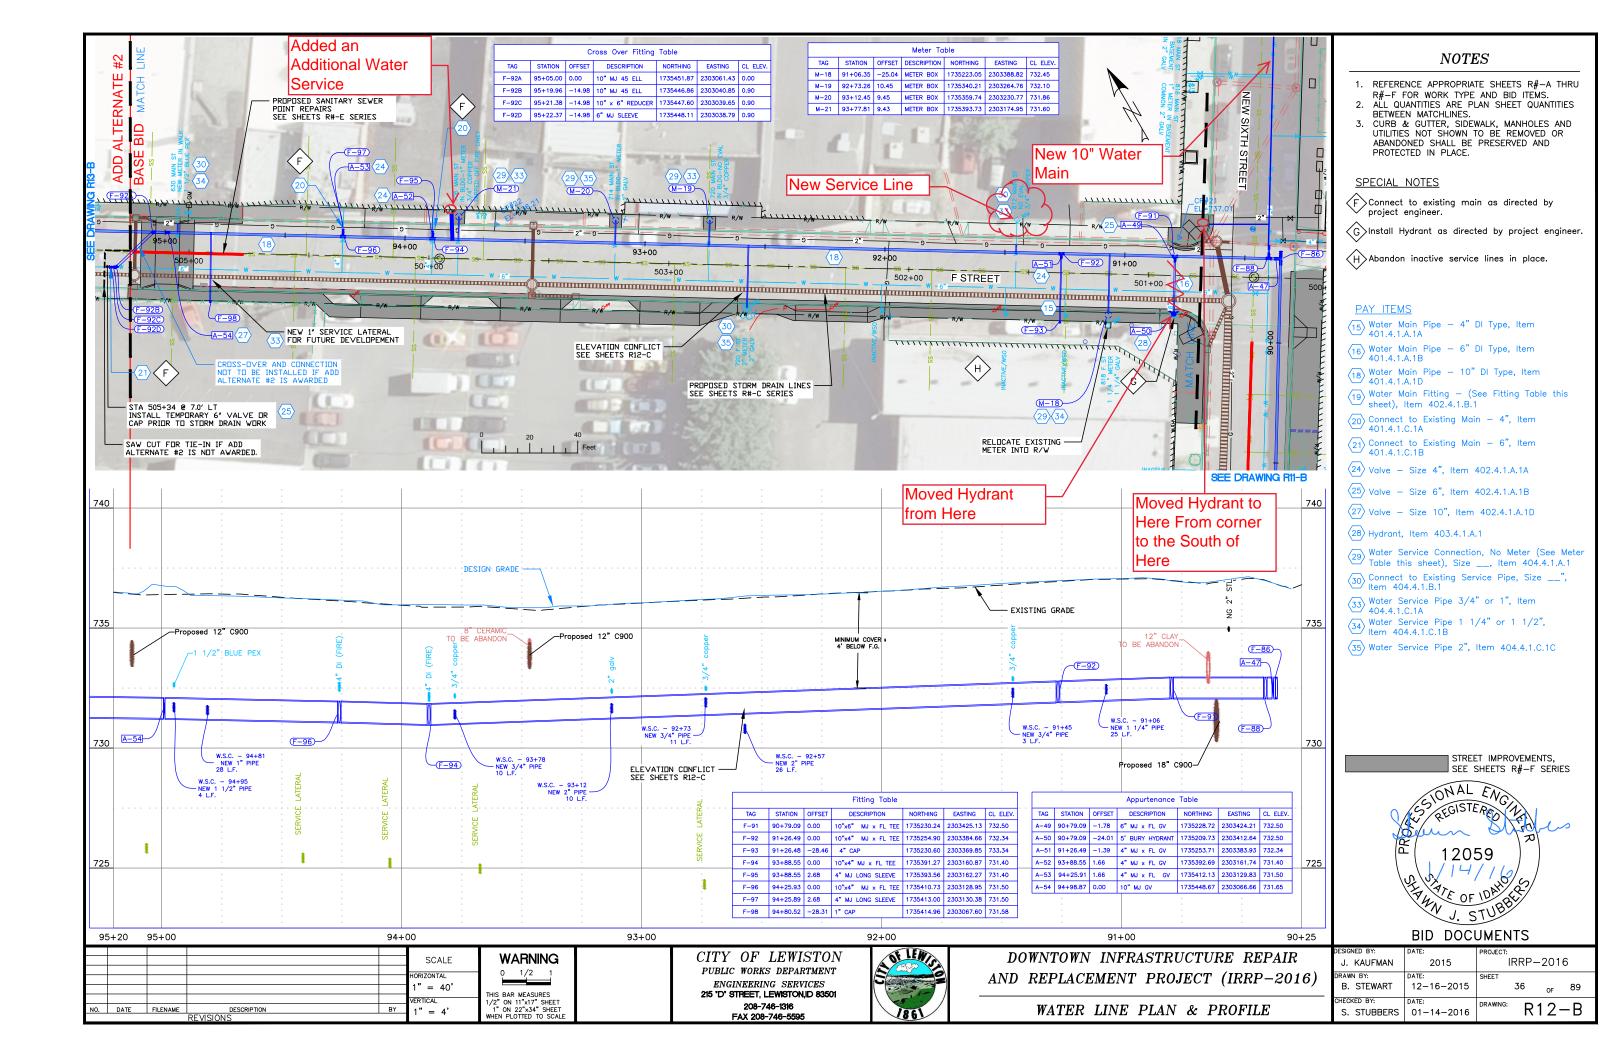

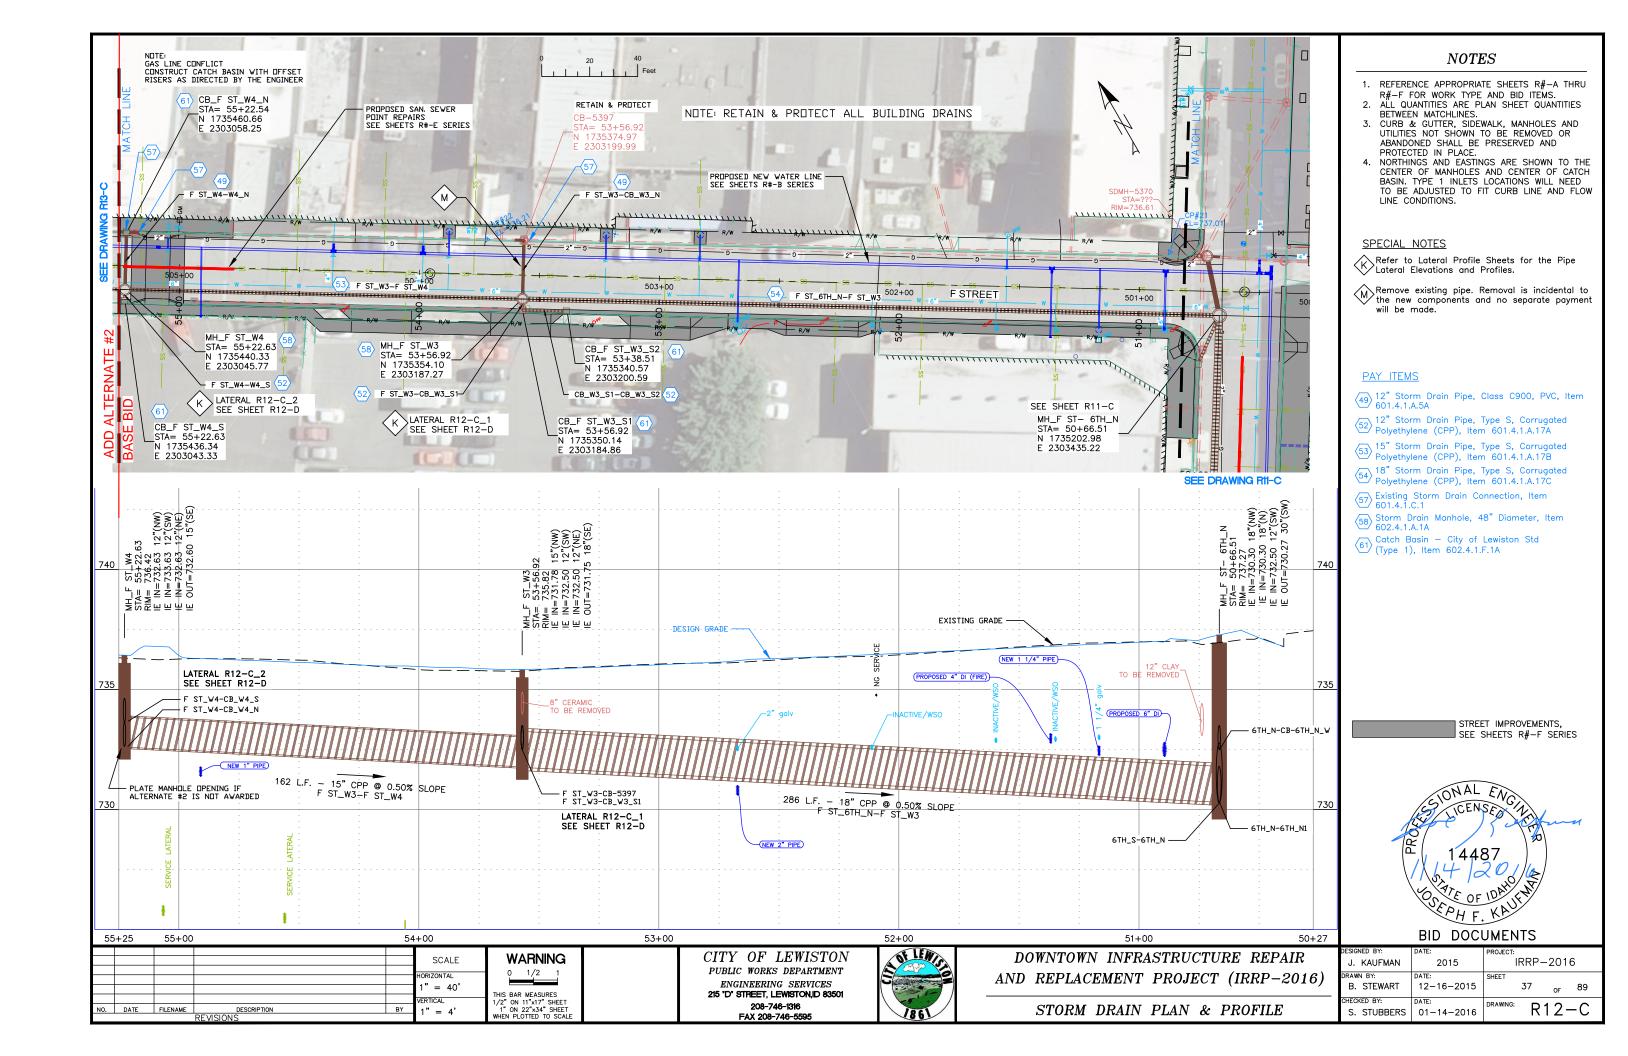

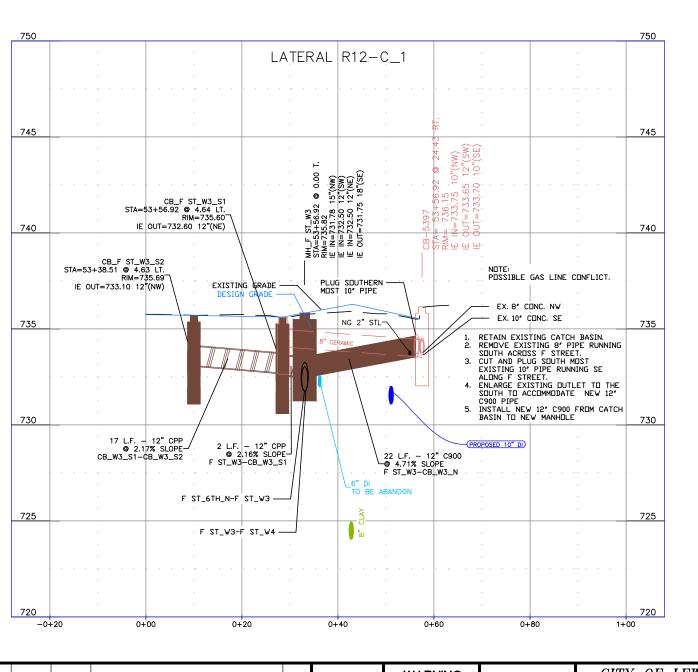

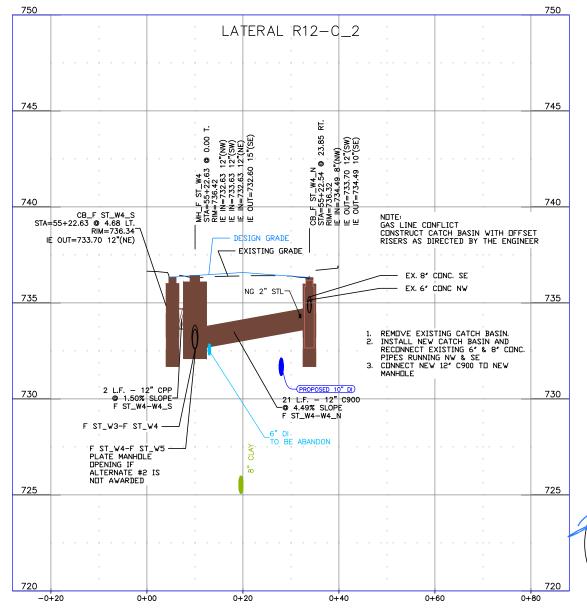

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BID DOCUMENTS


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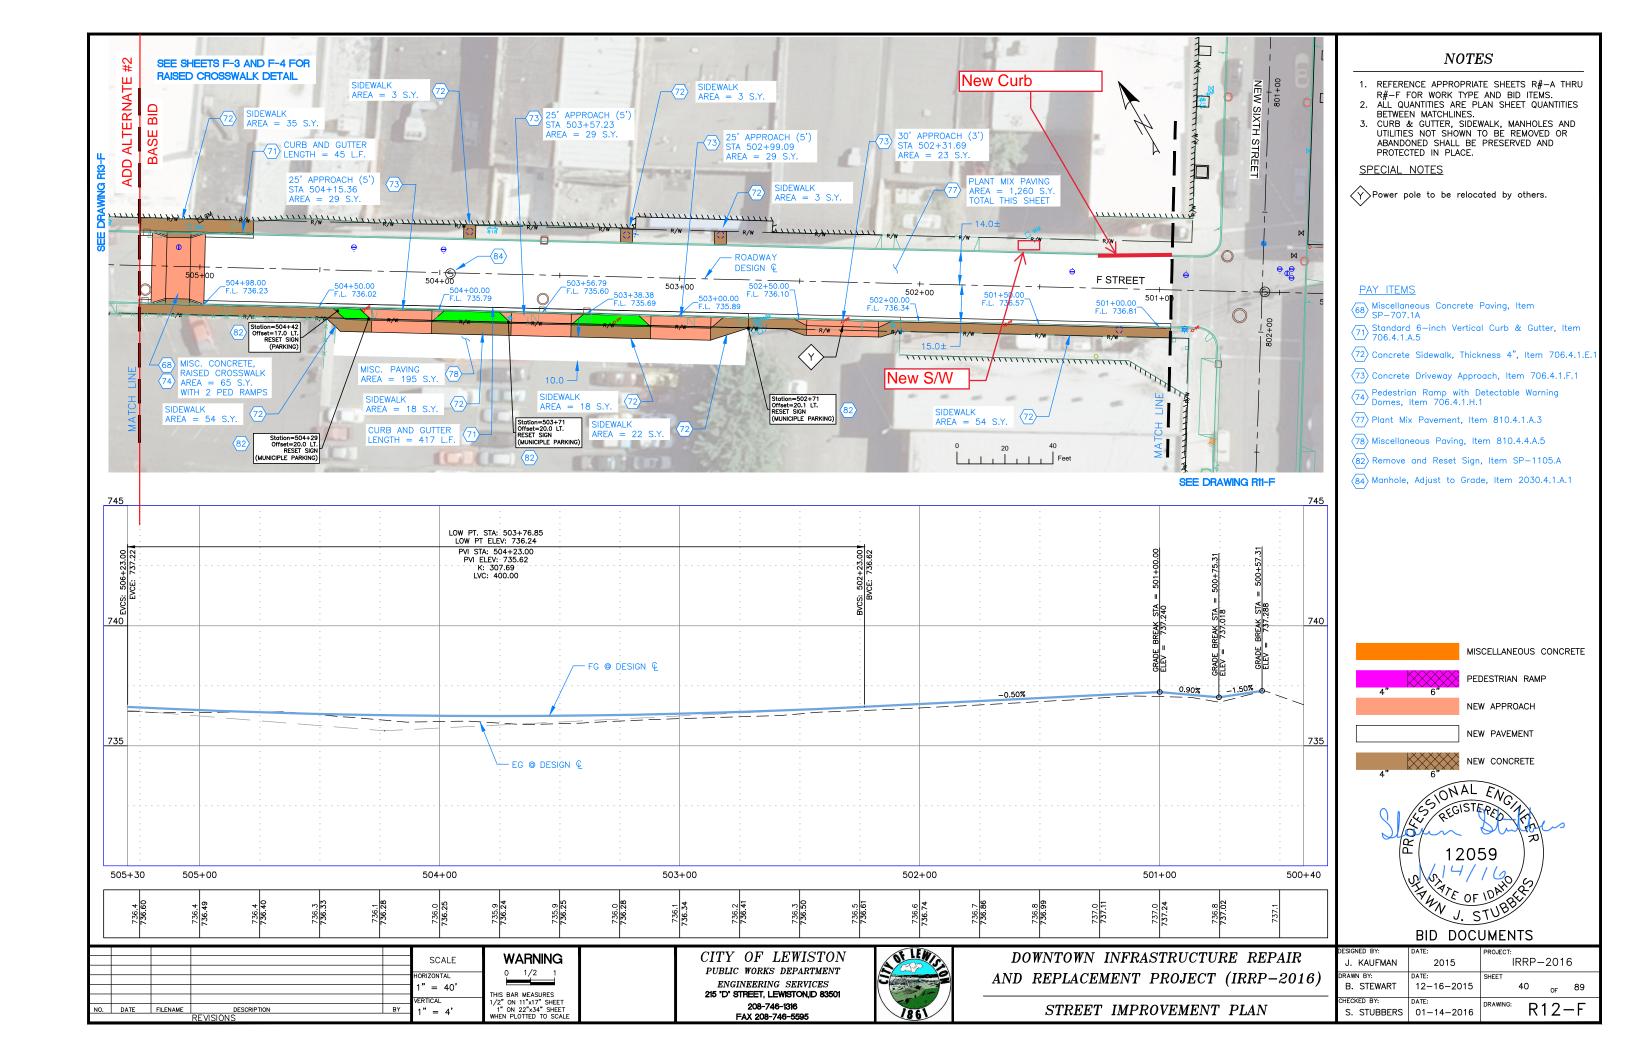
CITY OF LEWISTON
PUBLIC WORKS DEPARTMENT
ENGINEERING SERVICES
215 'D' STHEET, LEWISTON, ID 83501
208-746-1316
FAX 208-746-5595





DOWNTOWN INFRASTRUCTURE REPAIR AND REPLACEMENT PROJECT (IRRP-2016)


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DESIGNED BY:	DATE:	PROJECT:
J. KAUFMAN	2015	IRRP-2016
DRAWN BY:	DATE:	SHEET
B. STEWART	12-16-2015	38 _{OF} 89
CHECKED BY:	DATE:	DRAWING: DAO D
S. STUBBERS	01-14-2016	R12-D




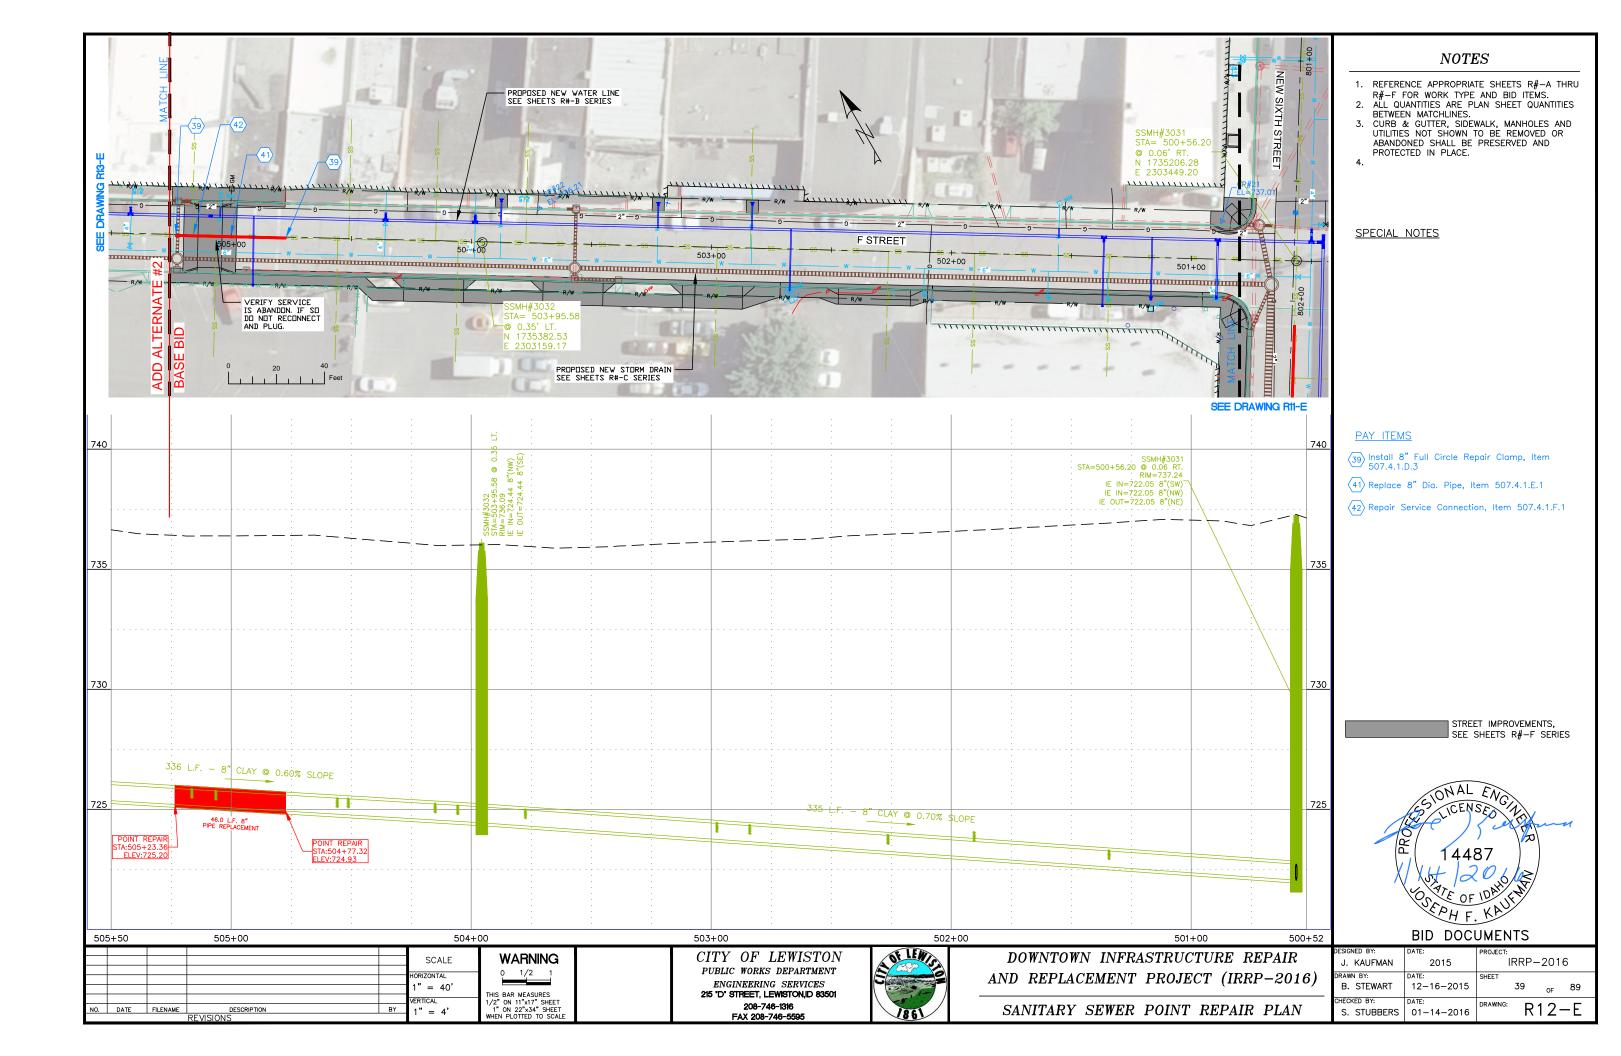


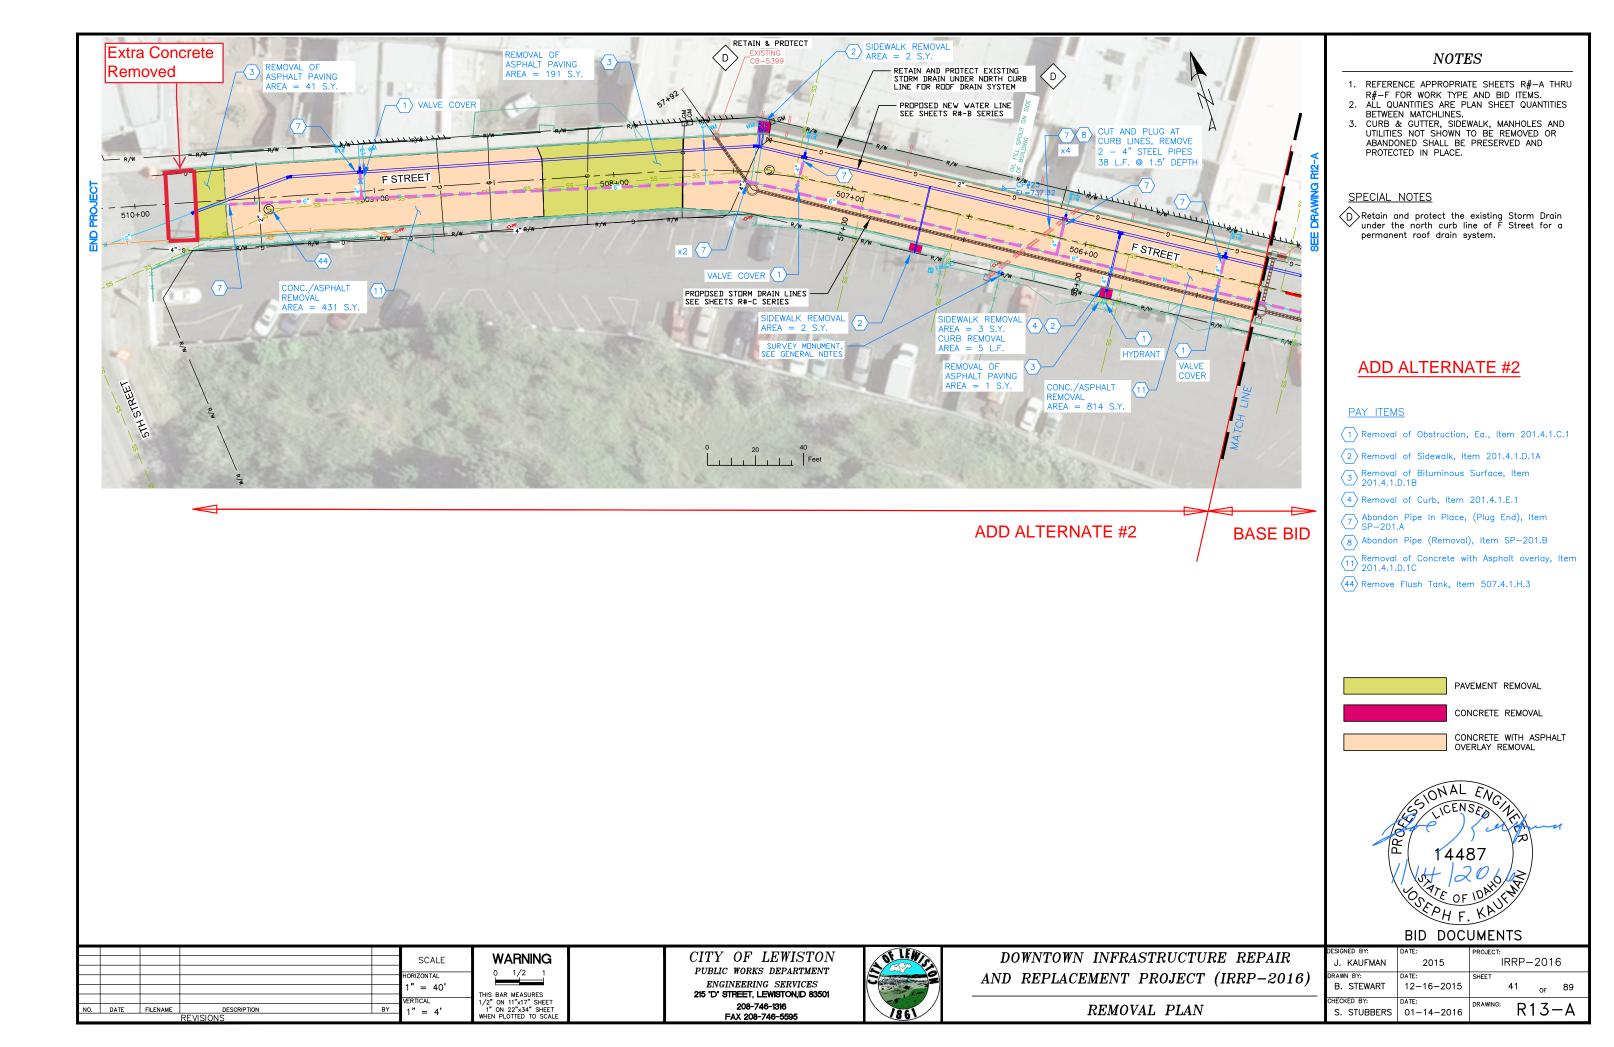


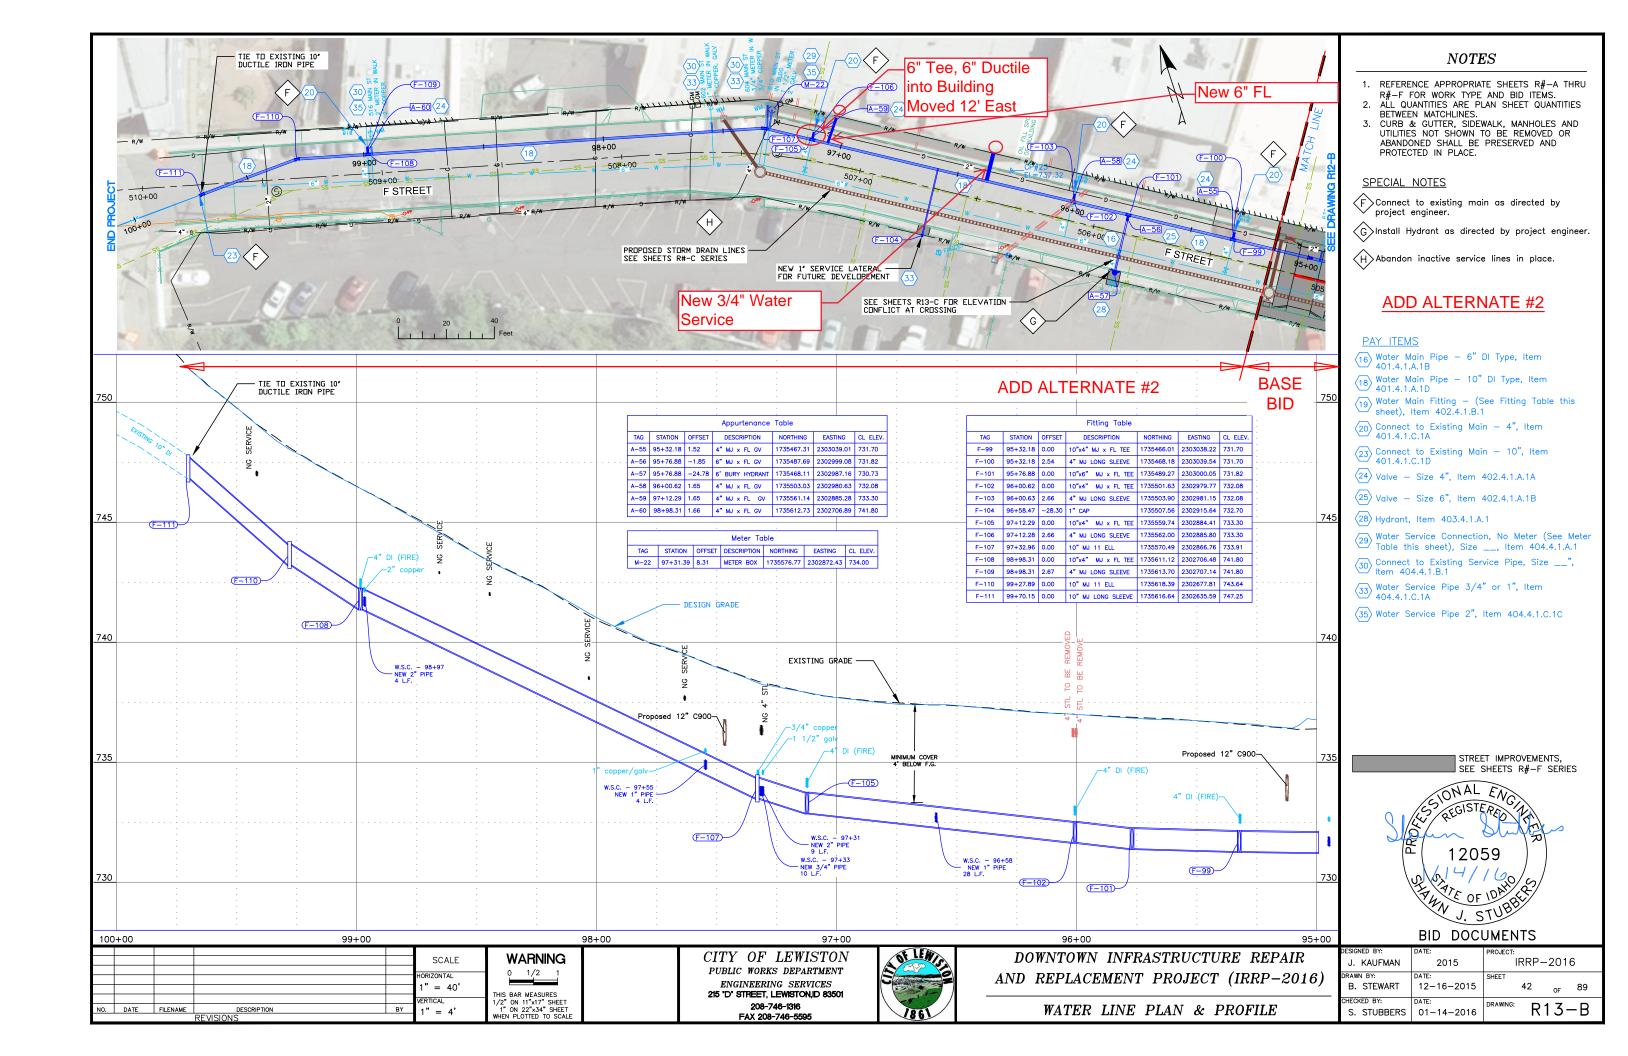


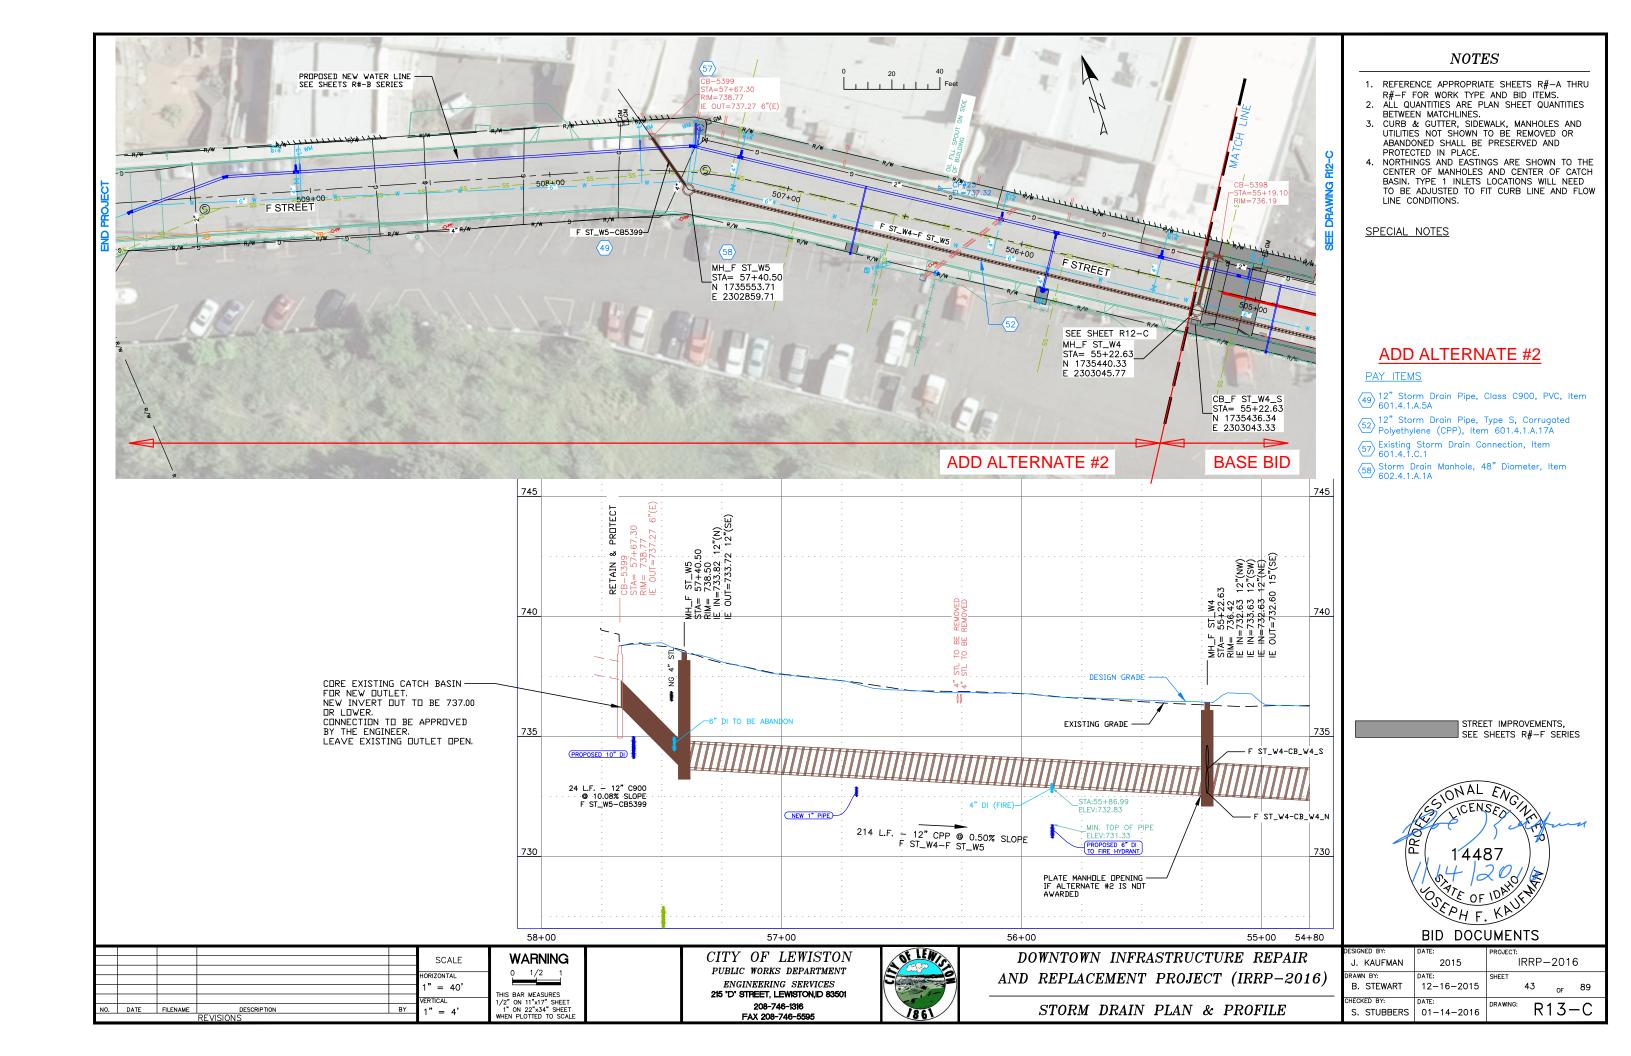


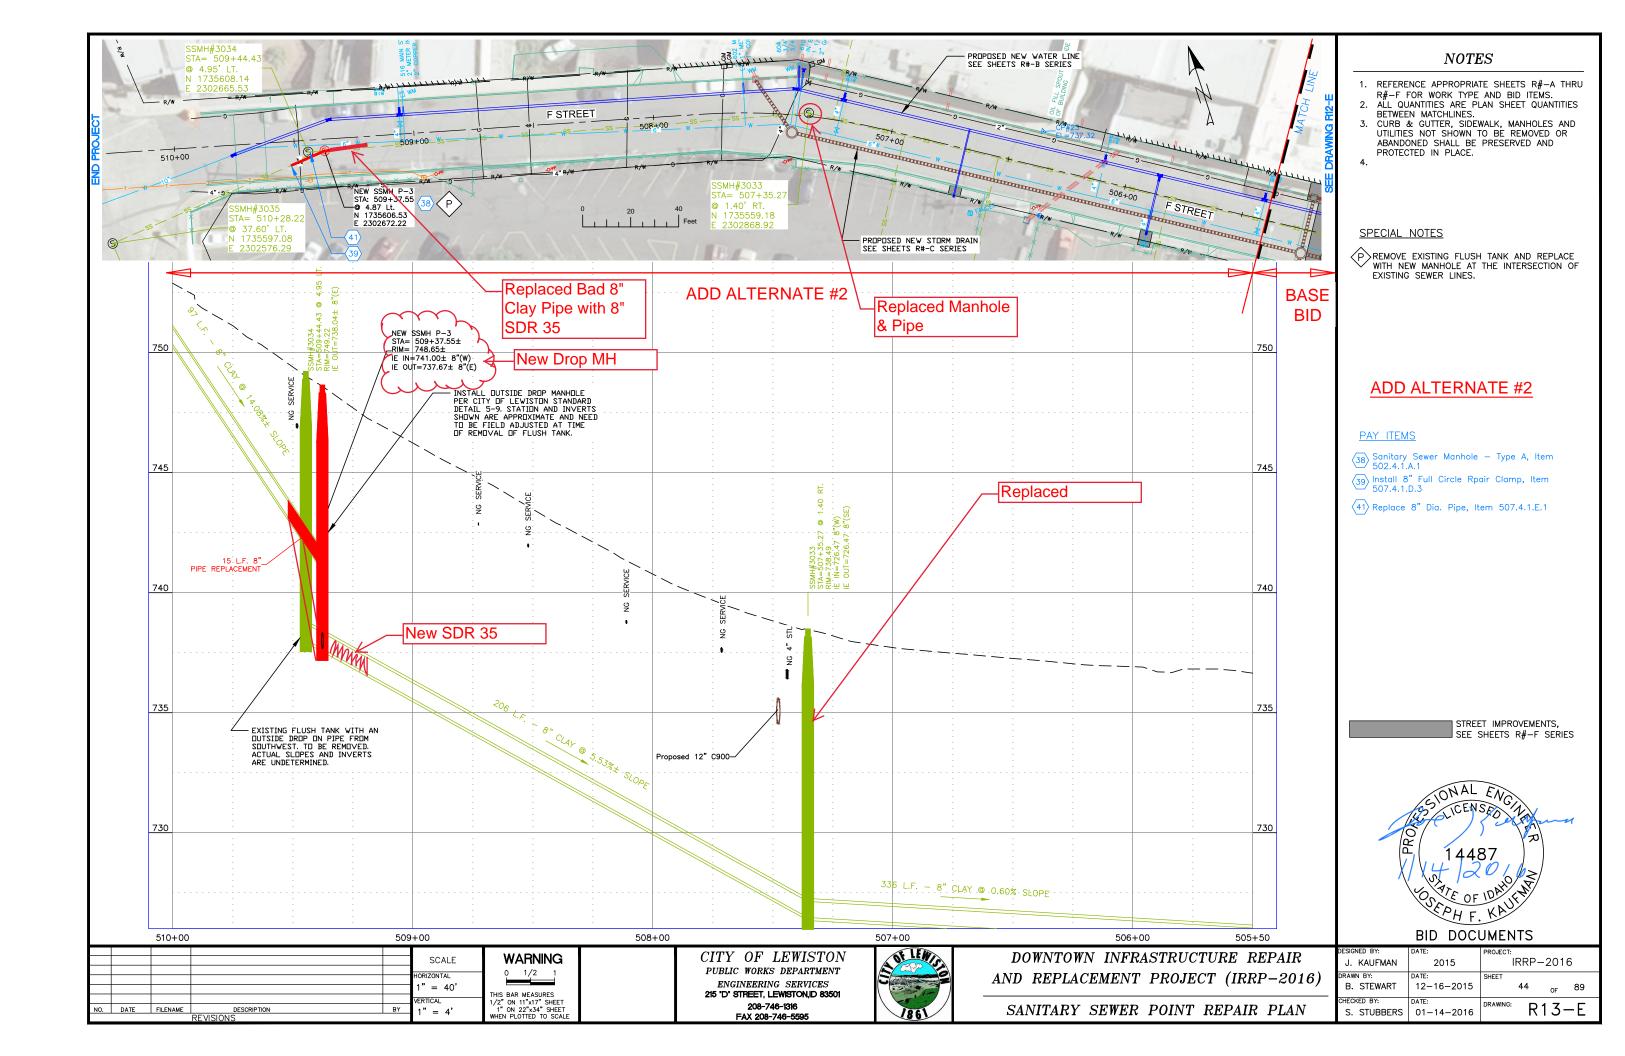


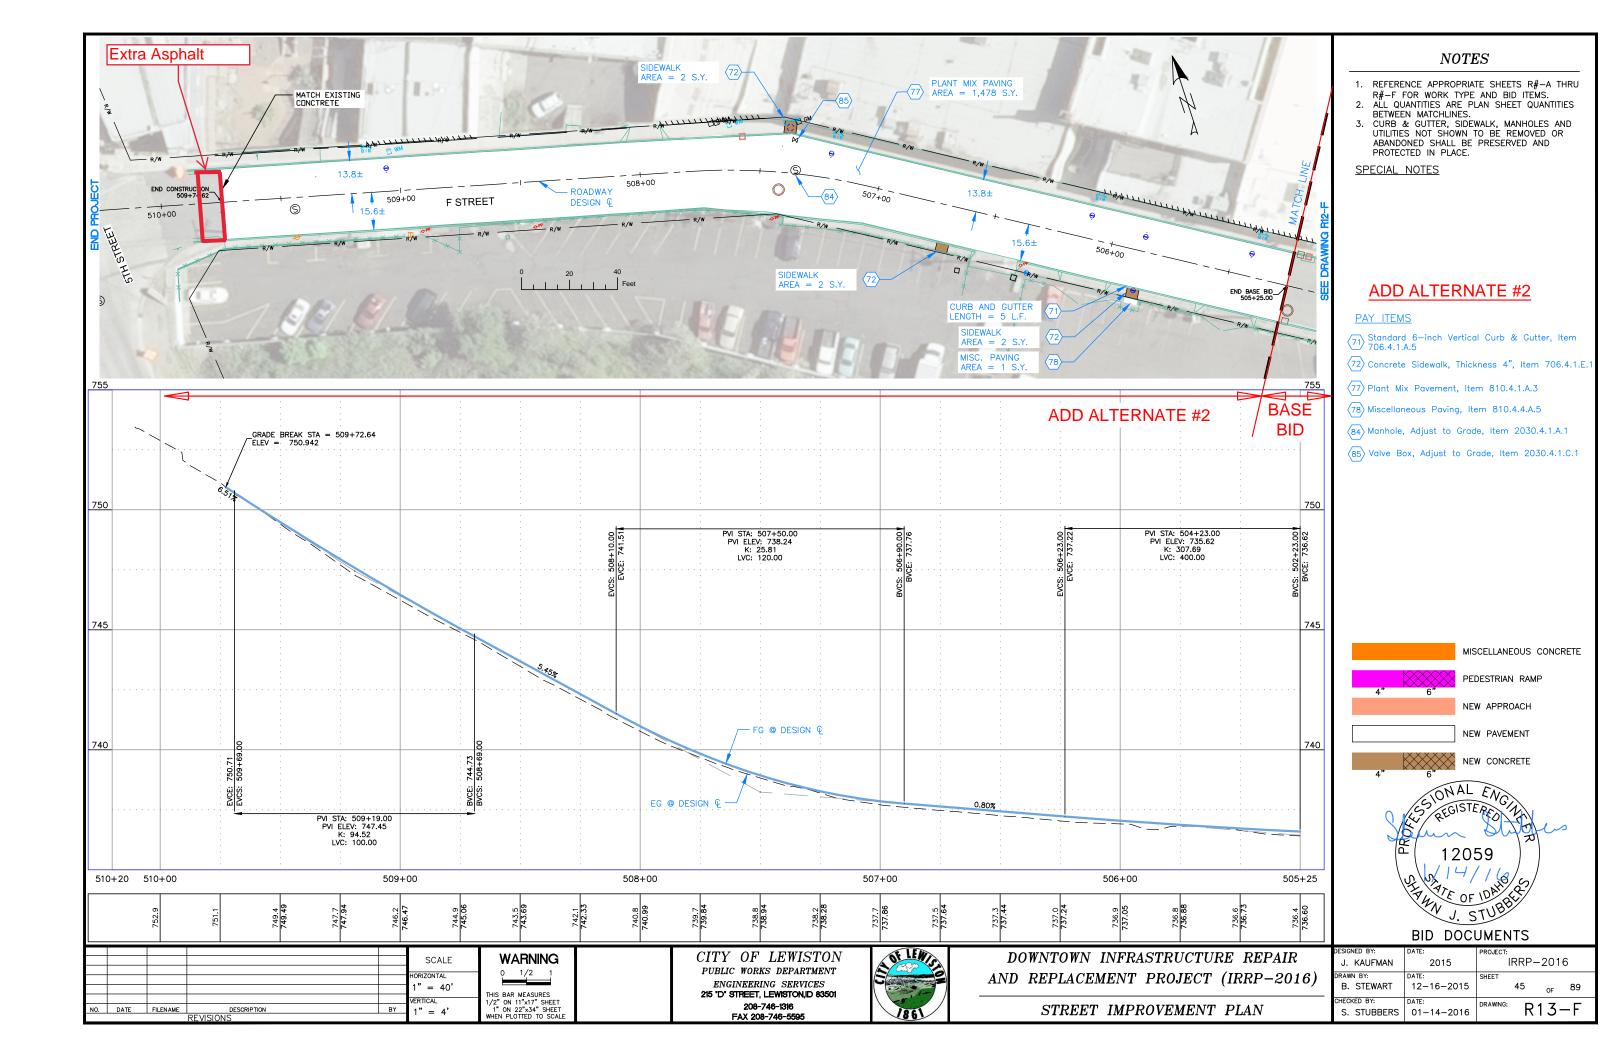


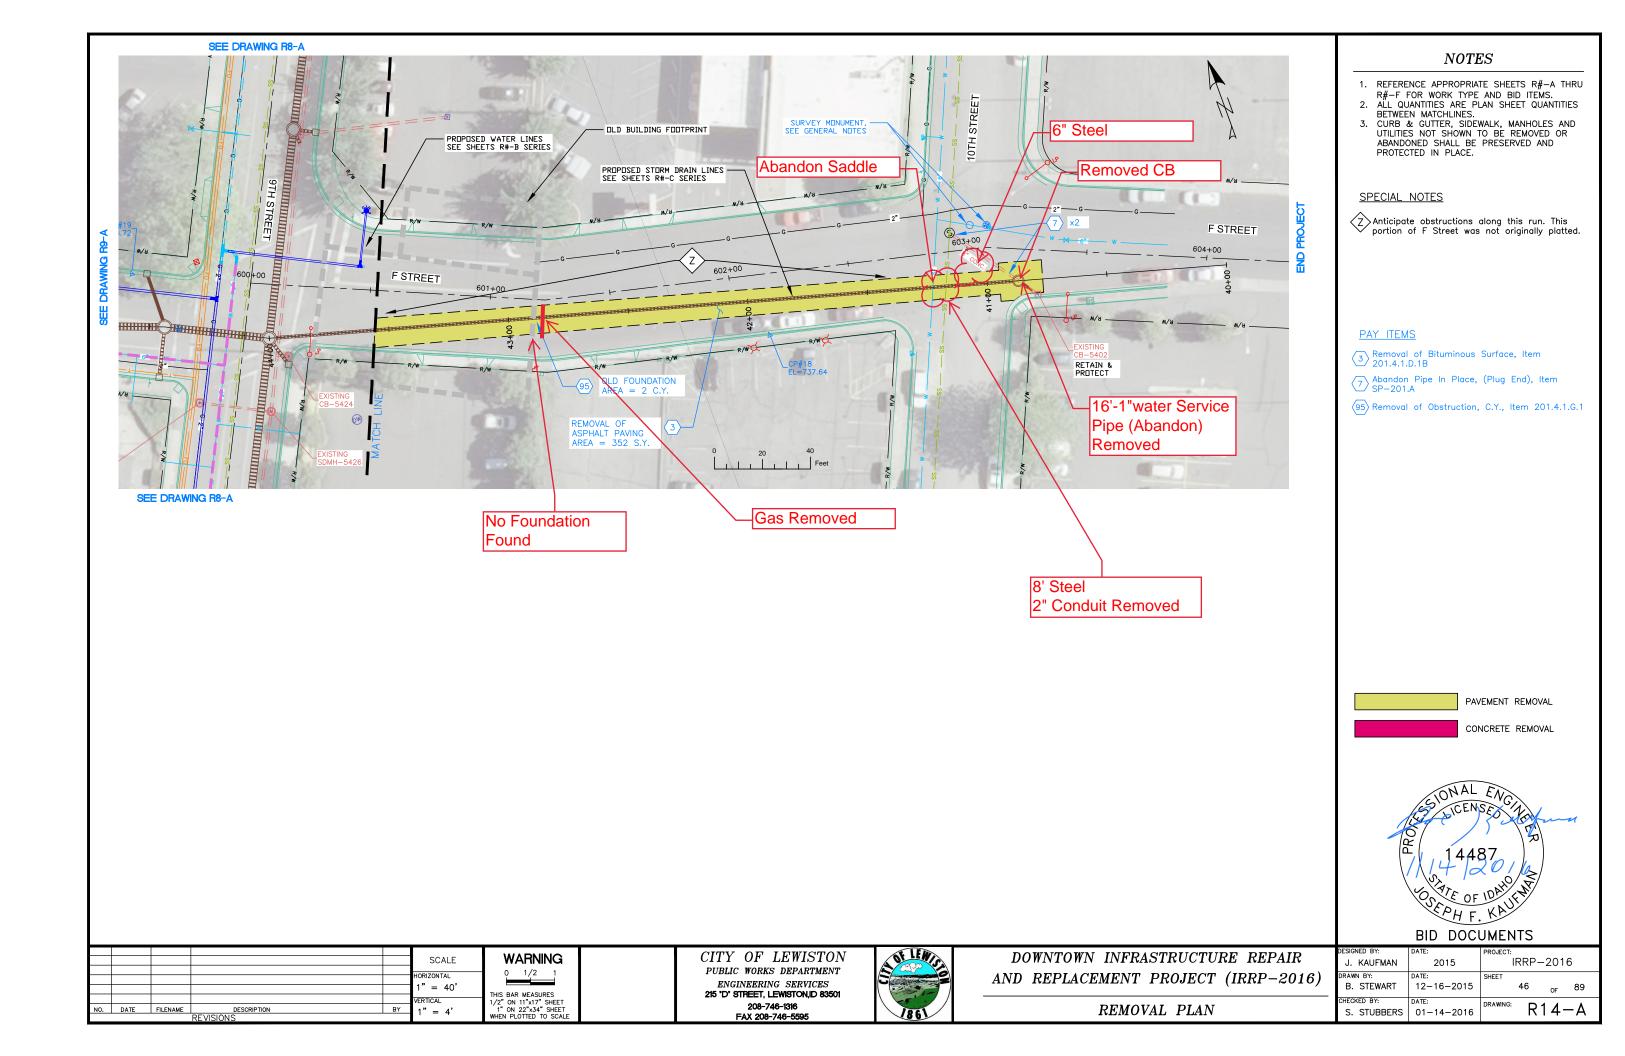

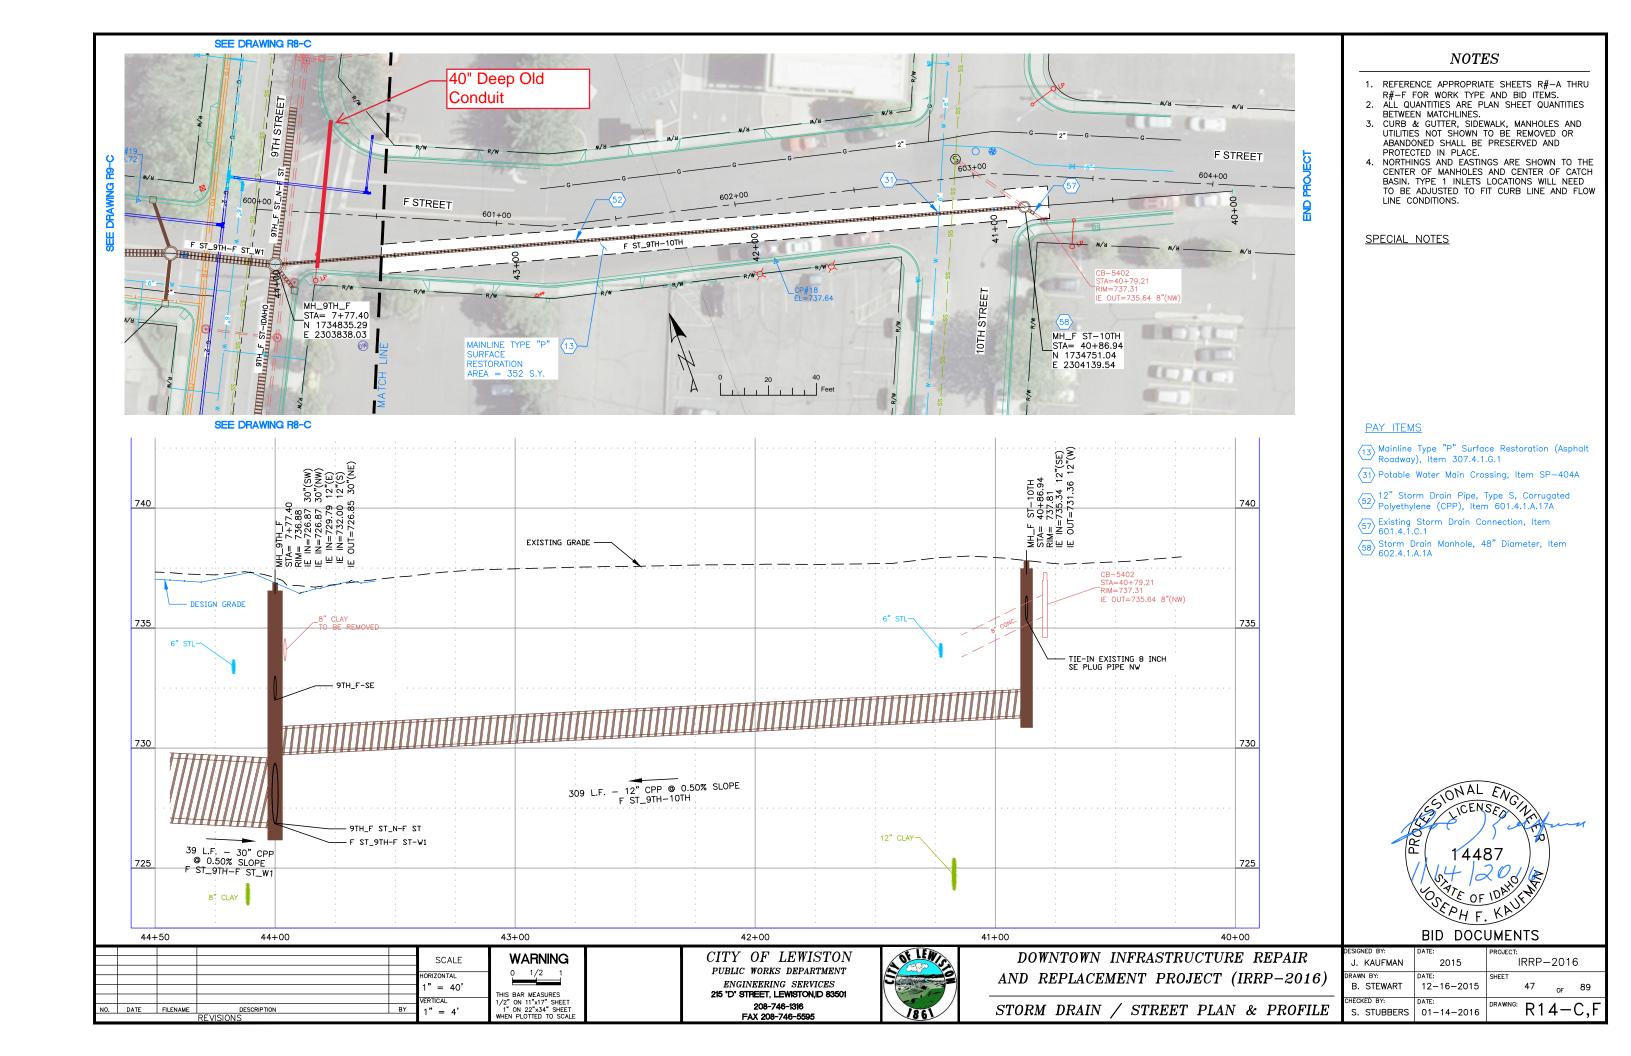

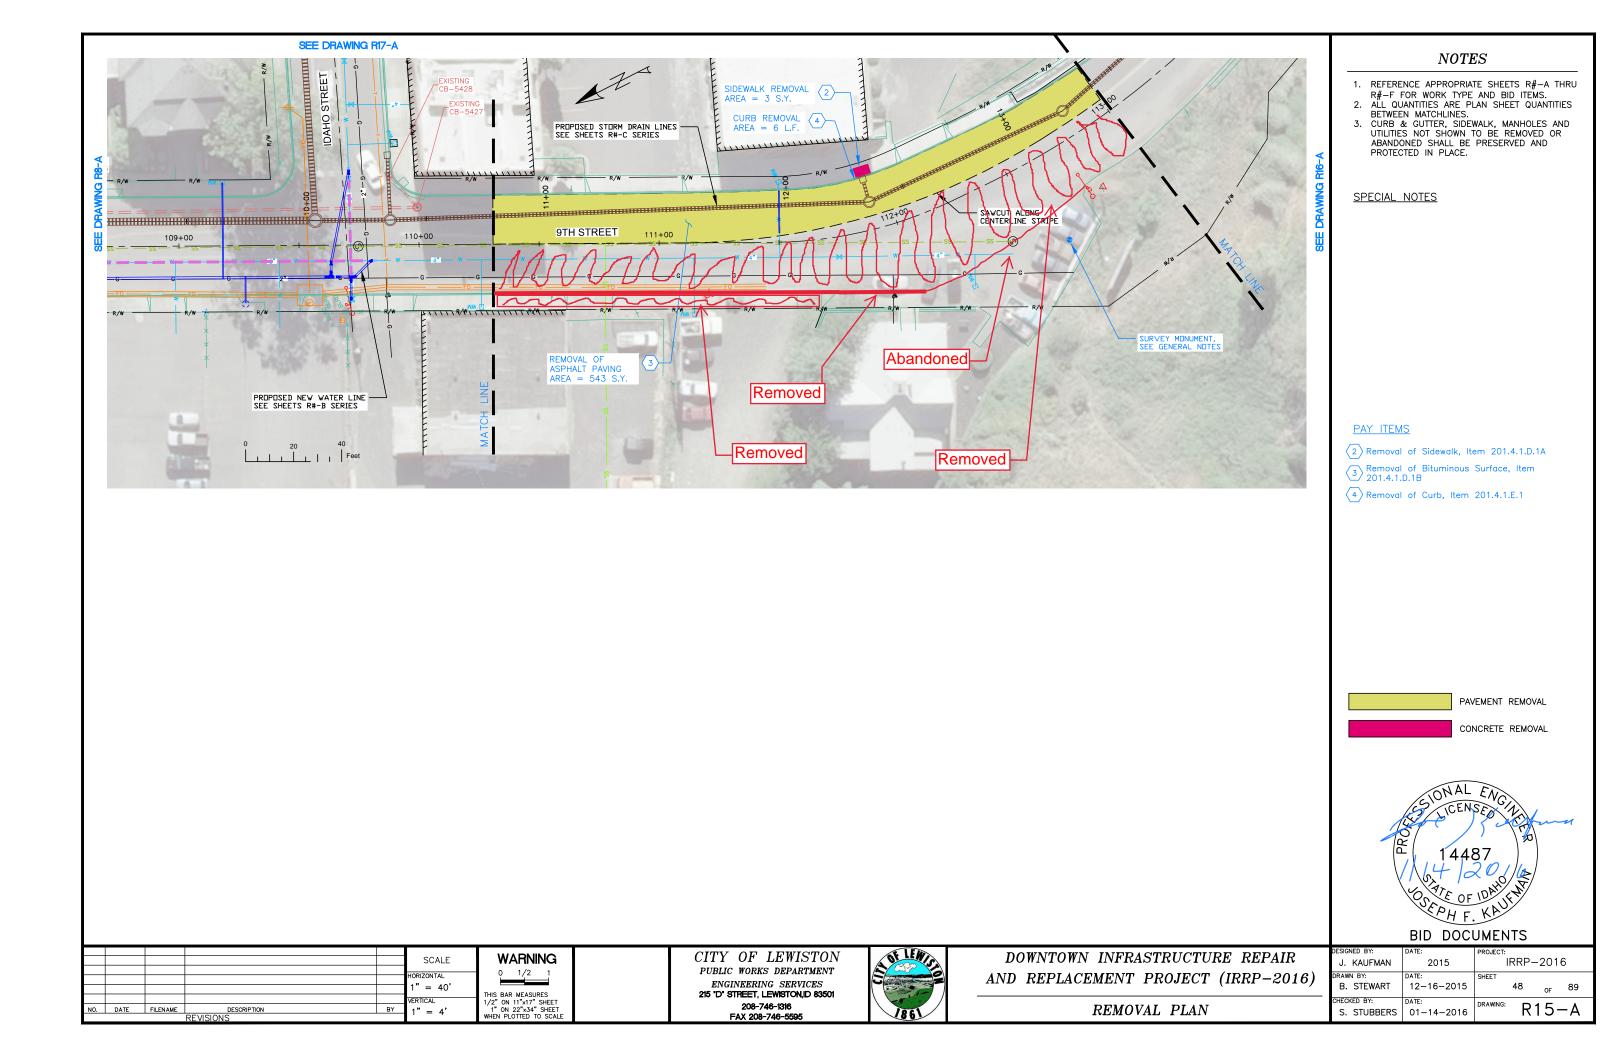

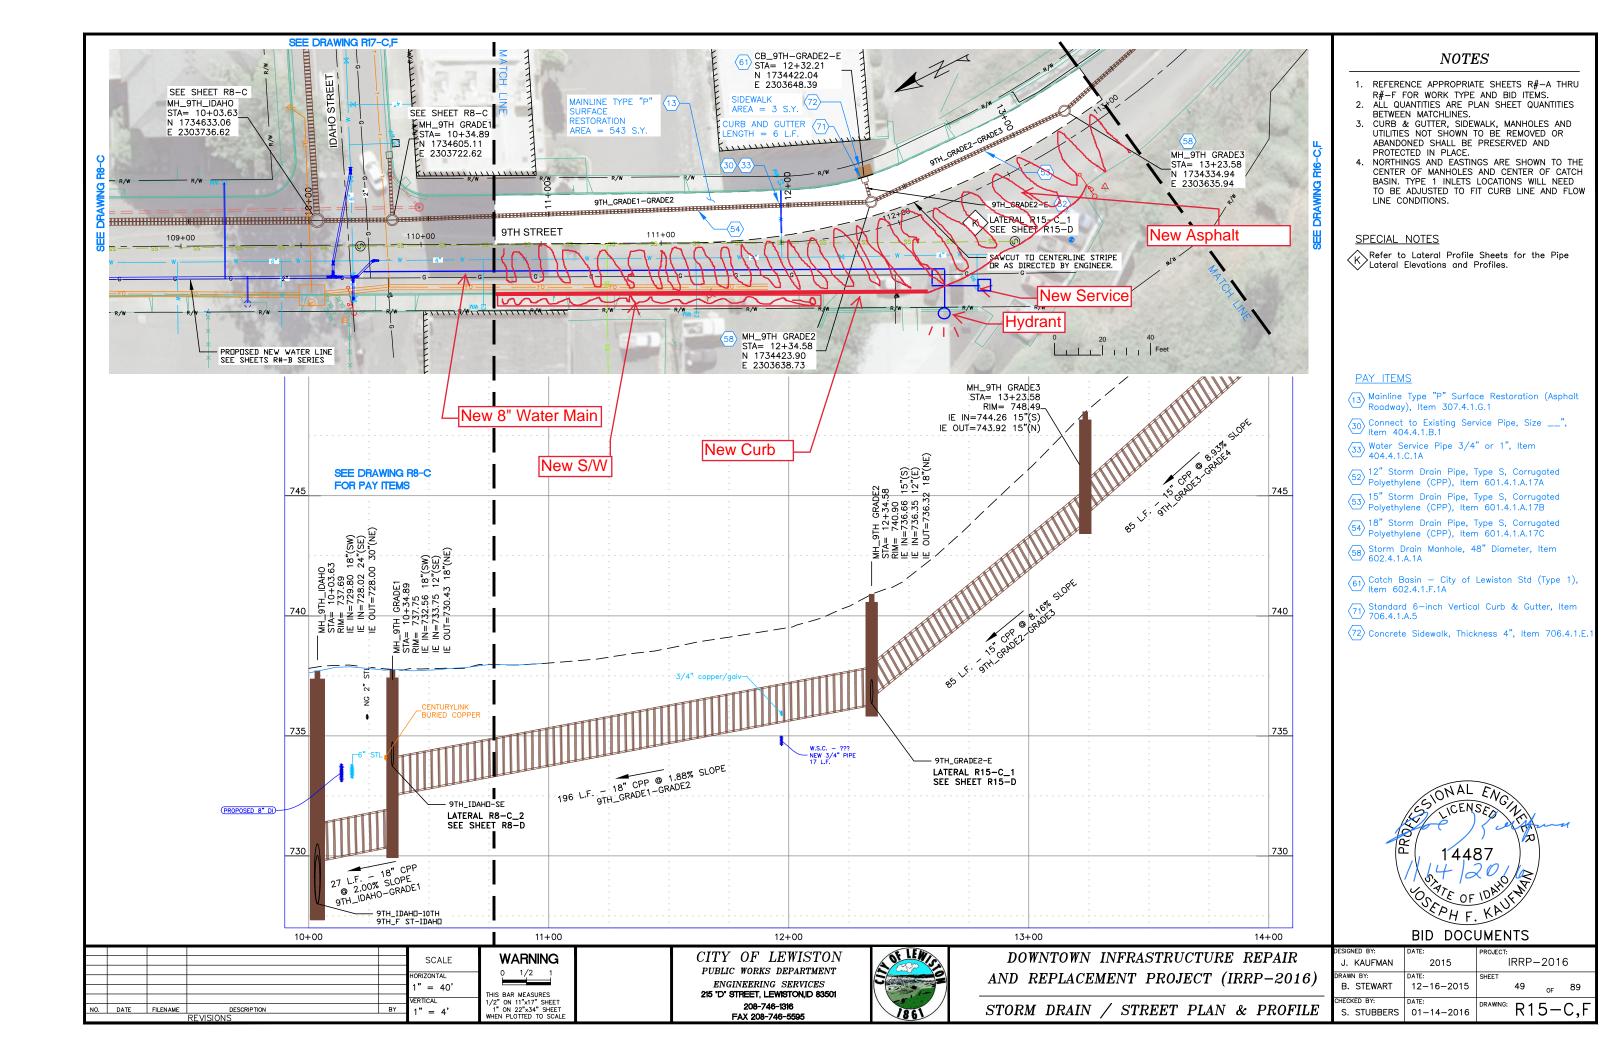

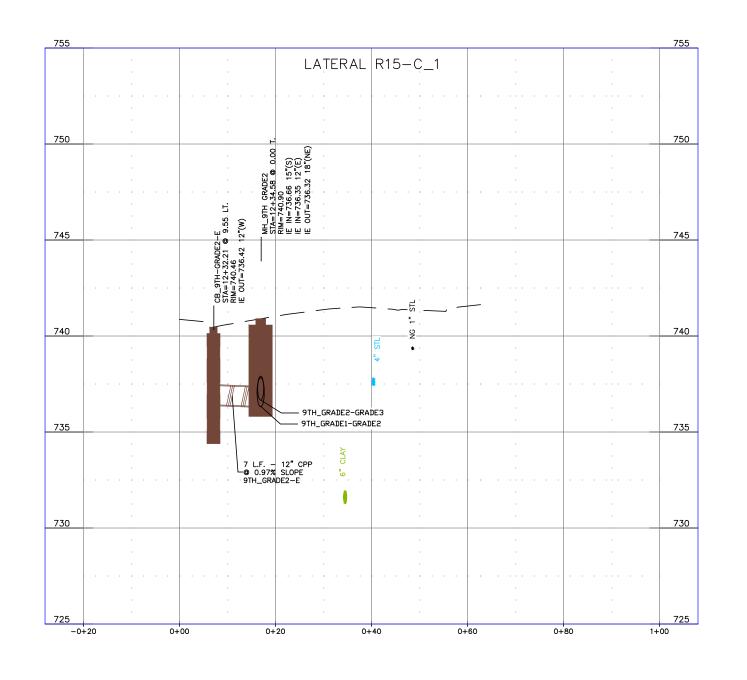



CITY OF LEWISTON DOWNTOWN INFRASTRUCTURE REPAIR **WARNING** SCALE PUBLIC WORKS DEPARTMENT 0 1/2 1

ENGINEERING SERVICES 215 'D' STREET, LEWISTON, ID 83501 THIS BAR MEASURES
1/2" ON 11"x17" SHEET
1" ON 22"x34" SHEET
WHEN PLOTTED TO SCALE 208-746-1316 FAX 208-746-5595

AS SHOWN

AS SHOWN


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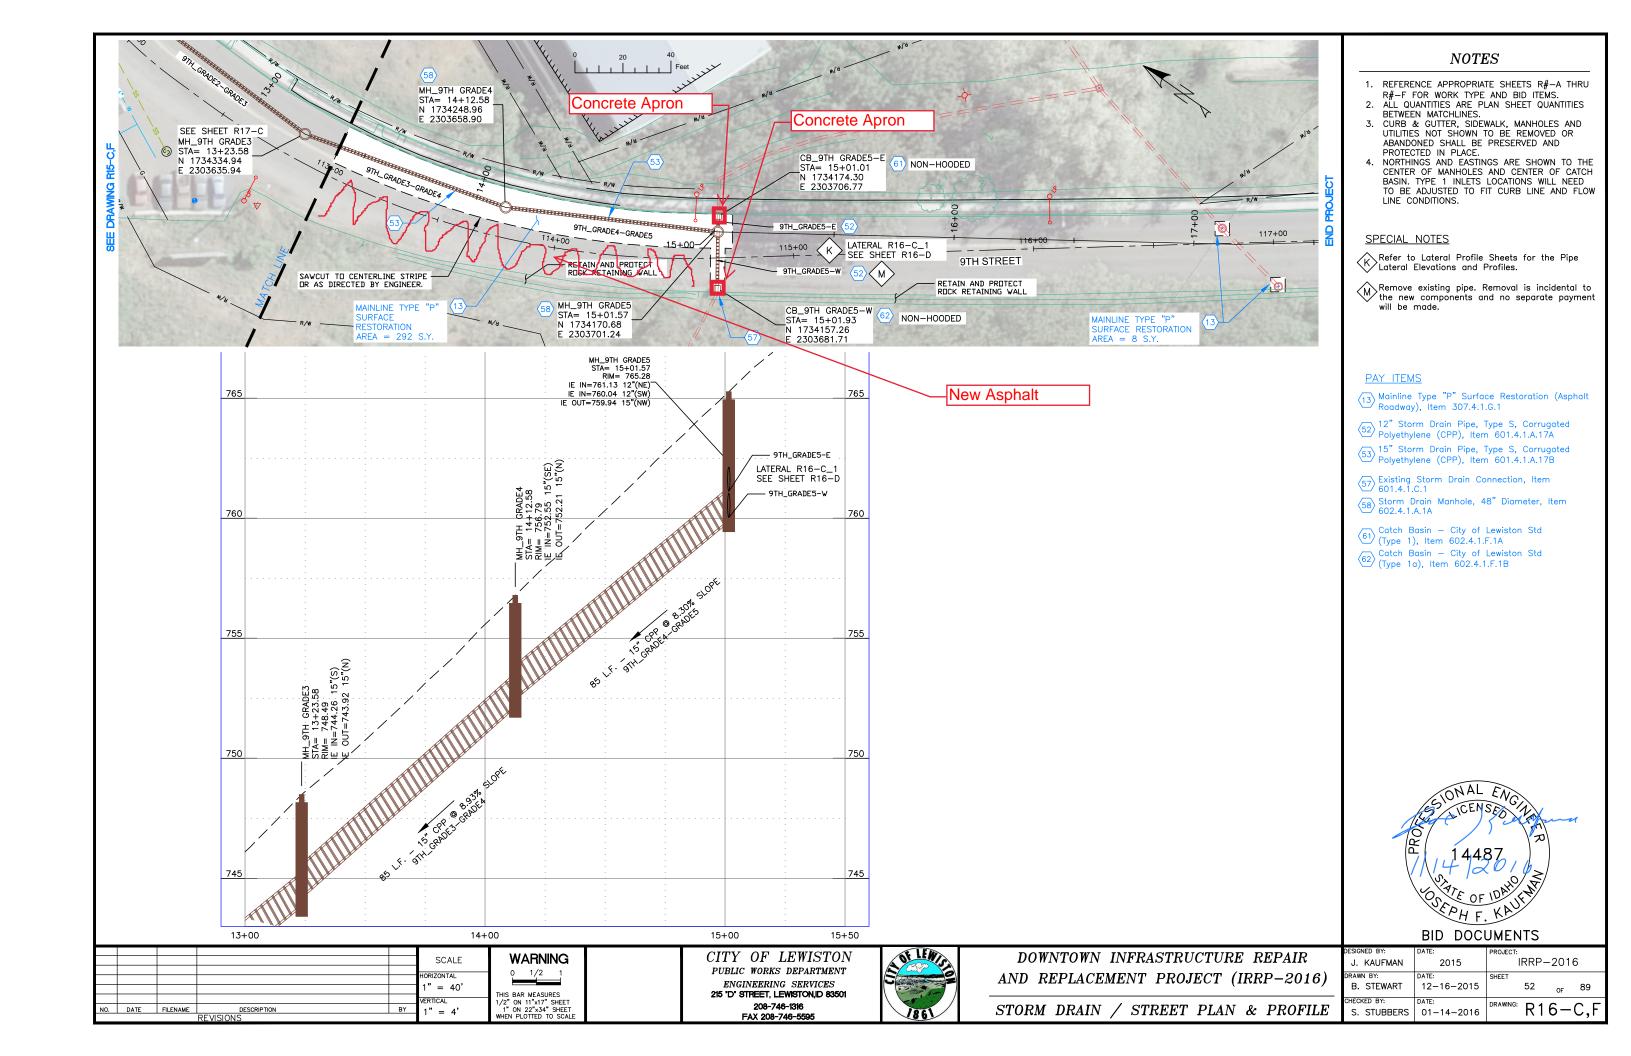



AND REPLACEMENT PROJECT (IRRP-2016)

STORM DRAIN LATERAL PROFII	LES
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	212 200	
DESIGNED BY:	DATE:	PROJECT:
J. KAUFMAN	2015	IRRP-2016
DRAWN BY:	DATE:	SHEET
B. STEWART	12-16-2015	50 _{OF} 89
CHECKED BY:	DATE:	DRAWING: DAF D
S. STUBBERS	01-14-2016	R15-D





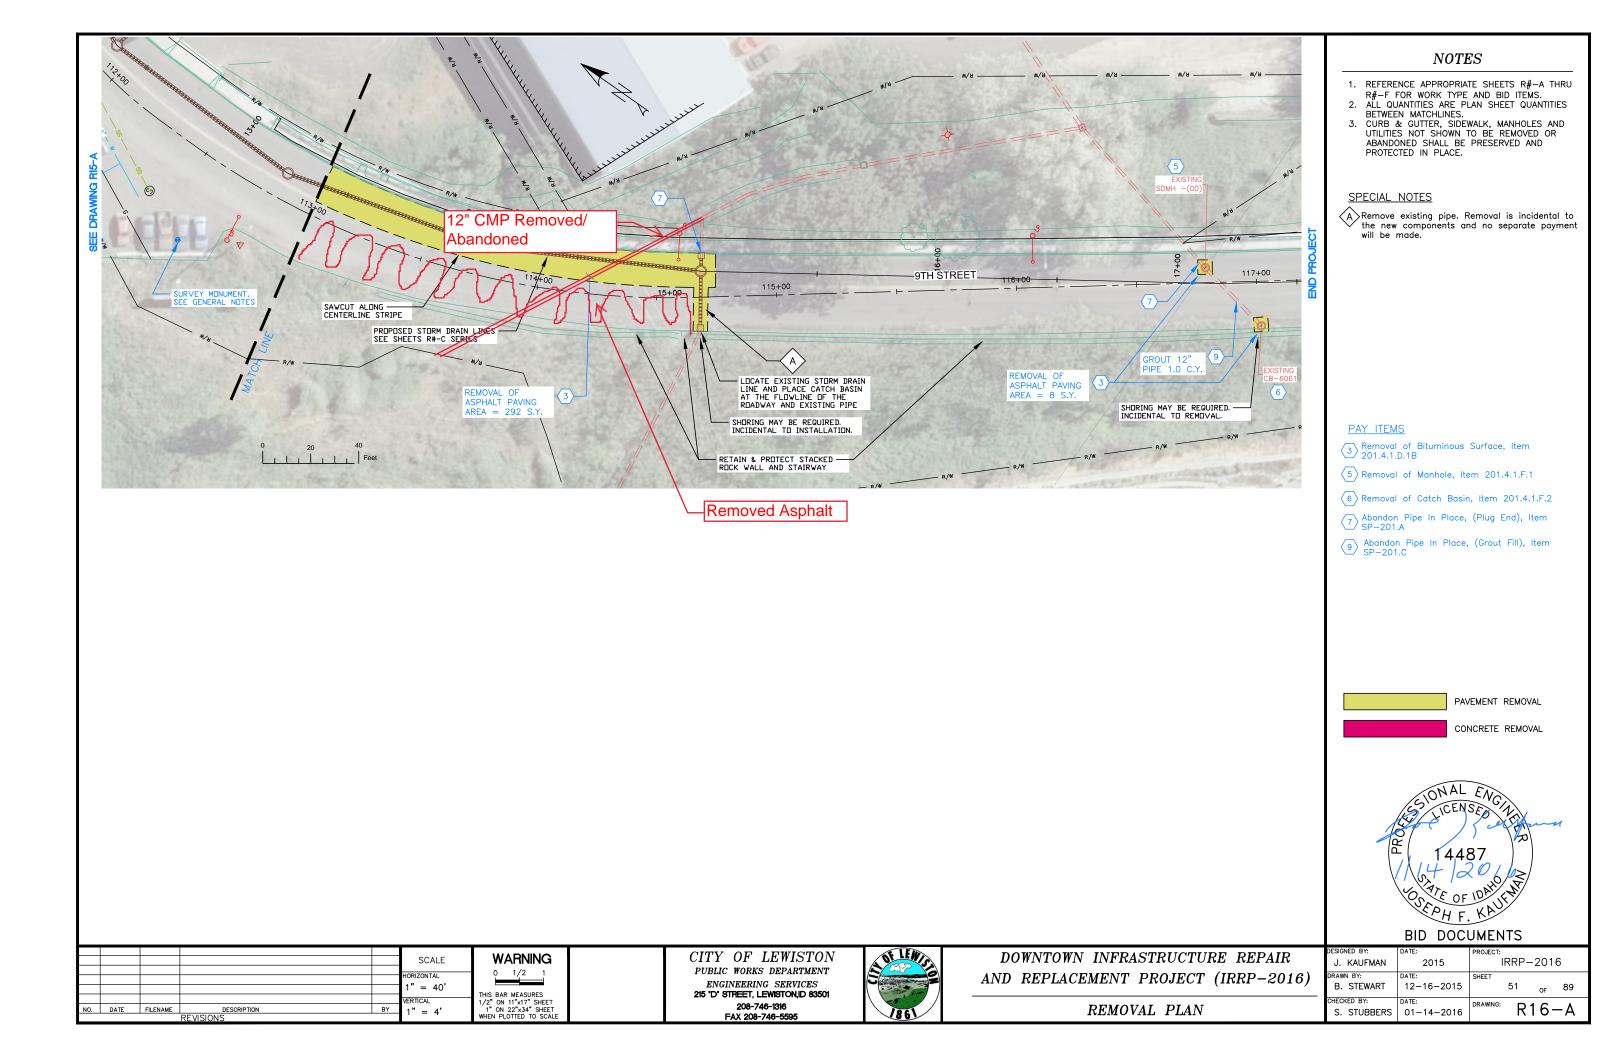

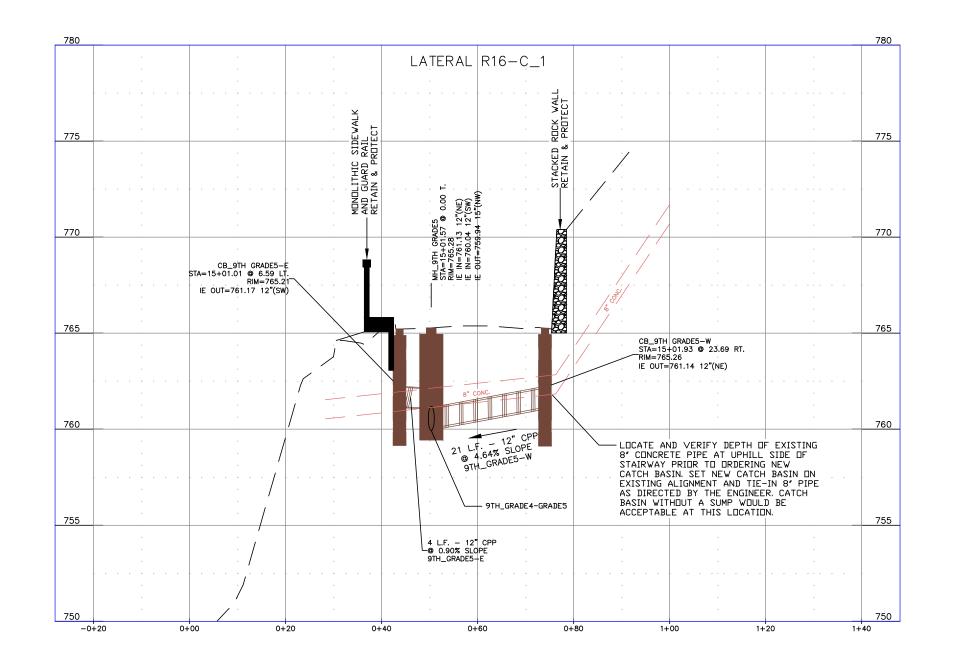


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				HORIZONTAL	0 1/2 1
				AS SHOWN VERTICAL	THIS BAR MEASURES 1/2" ON 11"x17" SHEET
 DATE	FILENAME	DESCRIPTION REVISIONS	BY	AS SHOWN	1" ON 22"x34" SHEET WHEN PLOTTED TO SCALE


CITY OF LEWISTON
PUBLIC WORKS DEPARTMENT
ENGINEERING SERVICES
215 'D' STREET, LEWISTON, ID 83501
208-746-1316
FAX 208-746-5595




DOWNTOWN INFRASTRUCTURE REPAIR
AND REPLACEMENT PROJECT (IRRP-2016)

		סום סום	OWILITIO
	DESIGNED BY:	DATE:	PROJECT:
	J. KAUFMAN	2015	IRRP-2016
ı	DRAWN BY:	DATE:	SHEET
	B. STEWART	12-16-2015	53 _{OF} 89
	CHECKED BY:	DATE:	DRAWING: DAC D
	S. STUBBERS	01-14-2016	R16-D

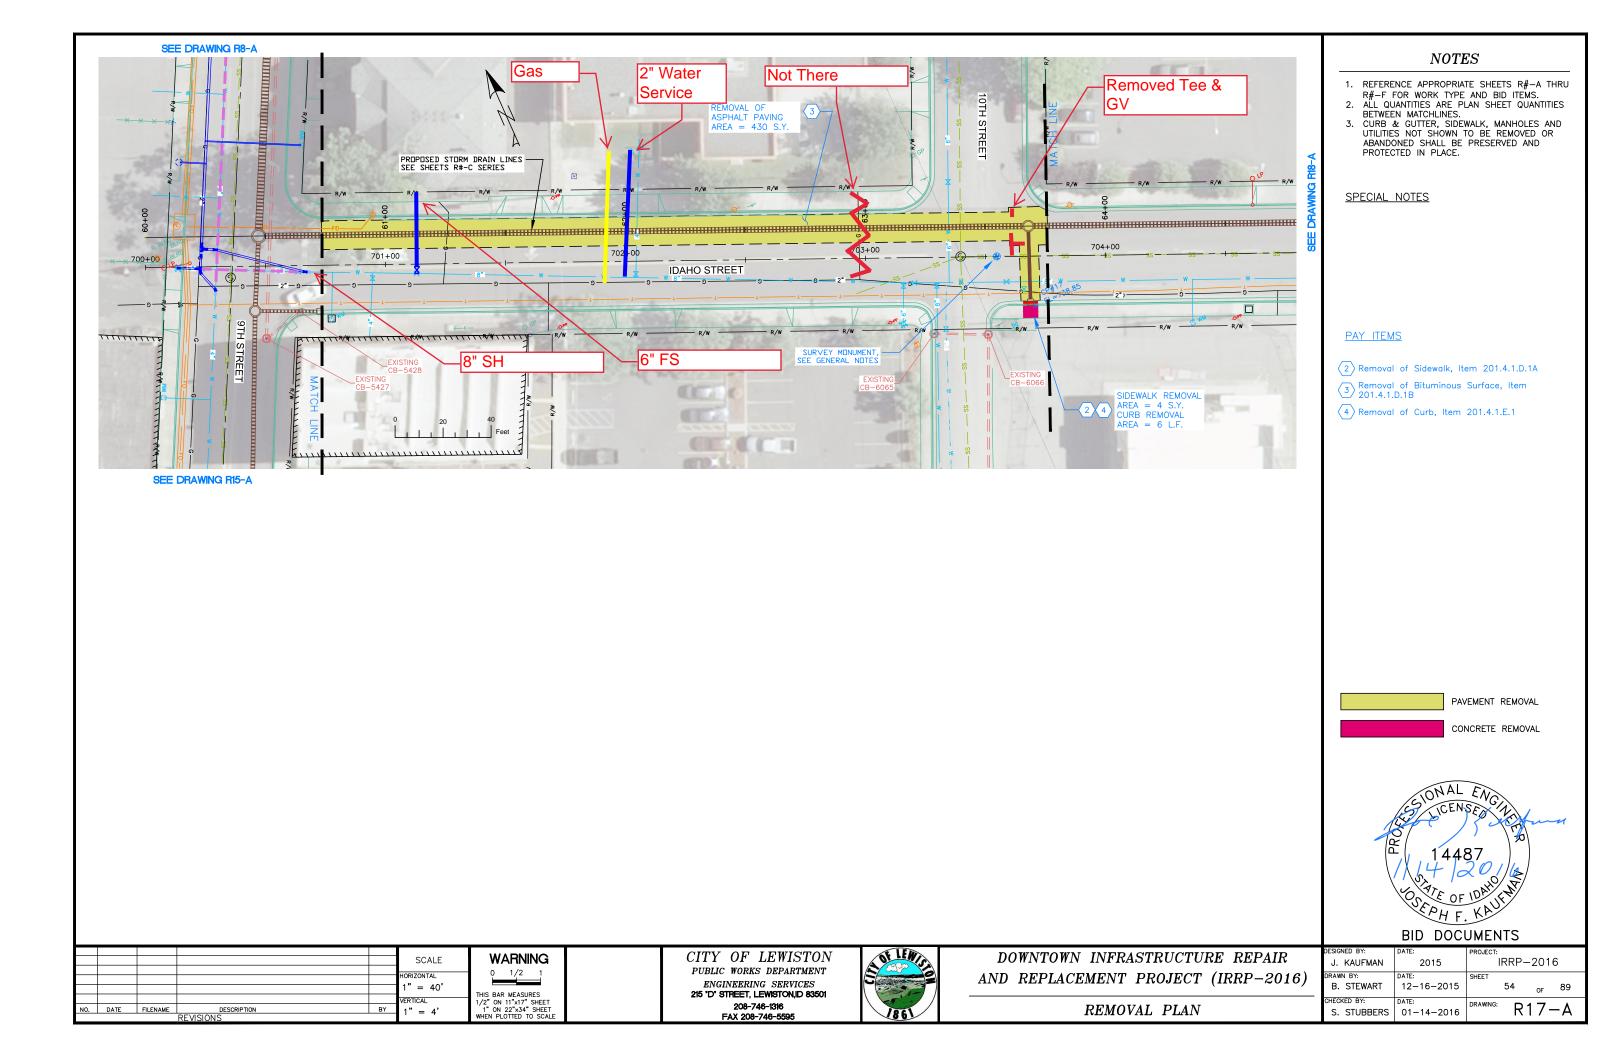

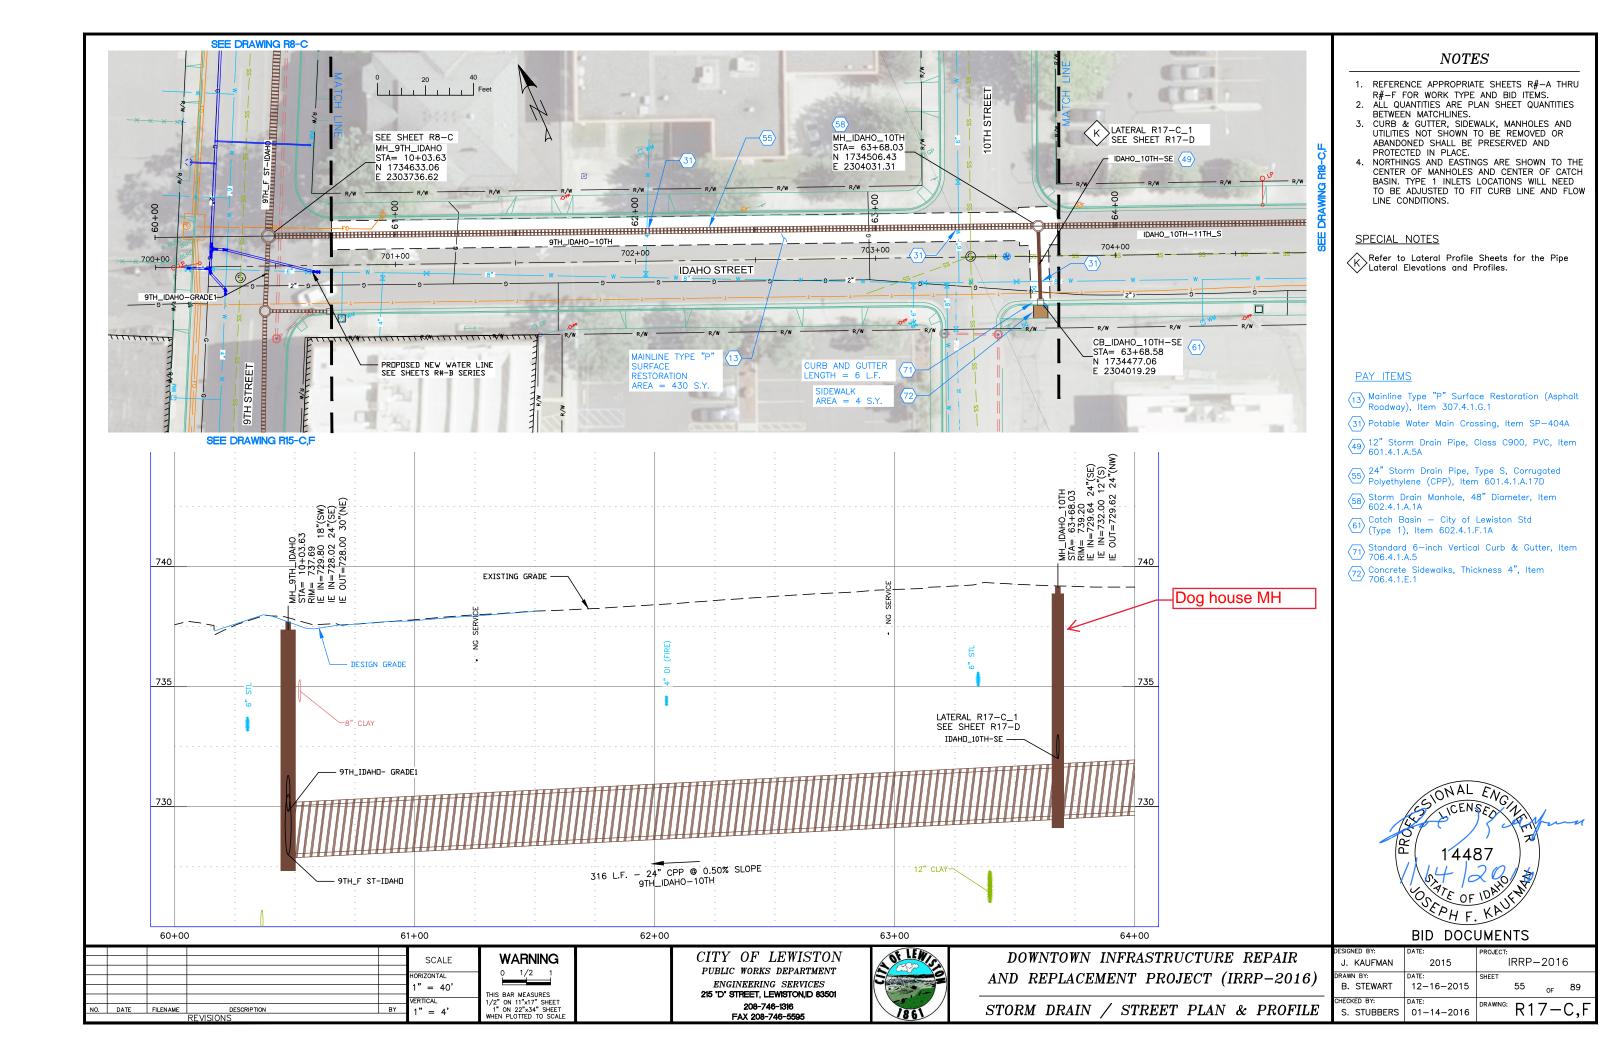

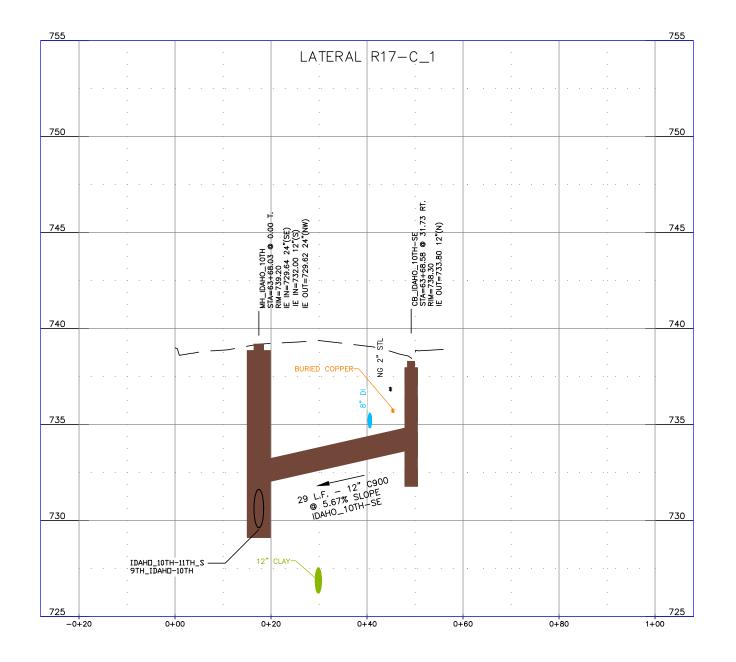



DOWNTOWN INFRASTRUCTURE REPAIR

DESIGNED BY:
J. KAUFMAN
2015

DATE: PROJECT

AND REPLACEMENT PROJECT (IRRP-2016)


STORM DRAIN LATERAL PROFILES


J. KAUFMAN	2015	I	RRP-	201	3
DRAWN BY:	DATE:	SHEET			
B. STEWART	12-16-2015		56	OF	89
CHECKED BY:	DATE:	DRAWING:		. –	
S. STUBBERS	01-14-2016		R.	l /-	- D


				SCALE	WARNING
				HORIZONTAL AS SHOWN	0 1/2 1 THIS BAR MEASURES
DATE	FILENAME	DESCRIPTION	BY	VERTICAL AS SHOWN	1/2" ON 11"x17" SHEET 1" ON 22"x34" SHEET
		REVISIONS		AS SHOWN	WHEN PLOTTED TO SCALE

CITY OF LEWISTON
PUBLIC WORKS DEPARTMENT
ENGINEERING SERVICES
215 "D" STREET, LEWISTON, ID 83501
208-746-1316
FAX 208-746-5595



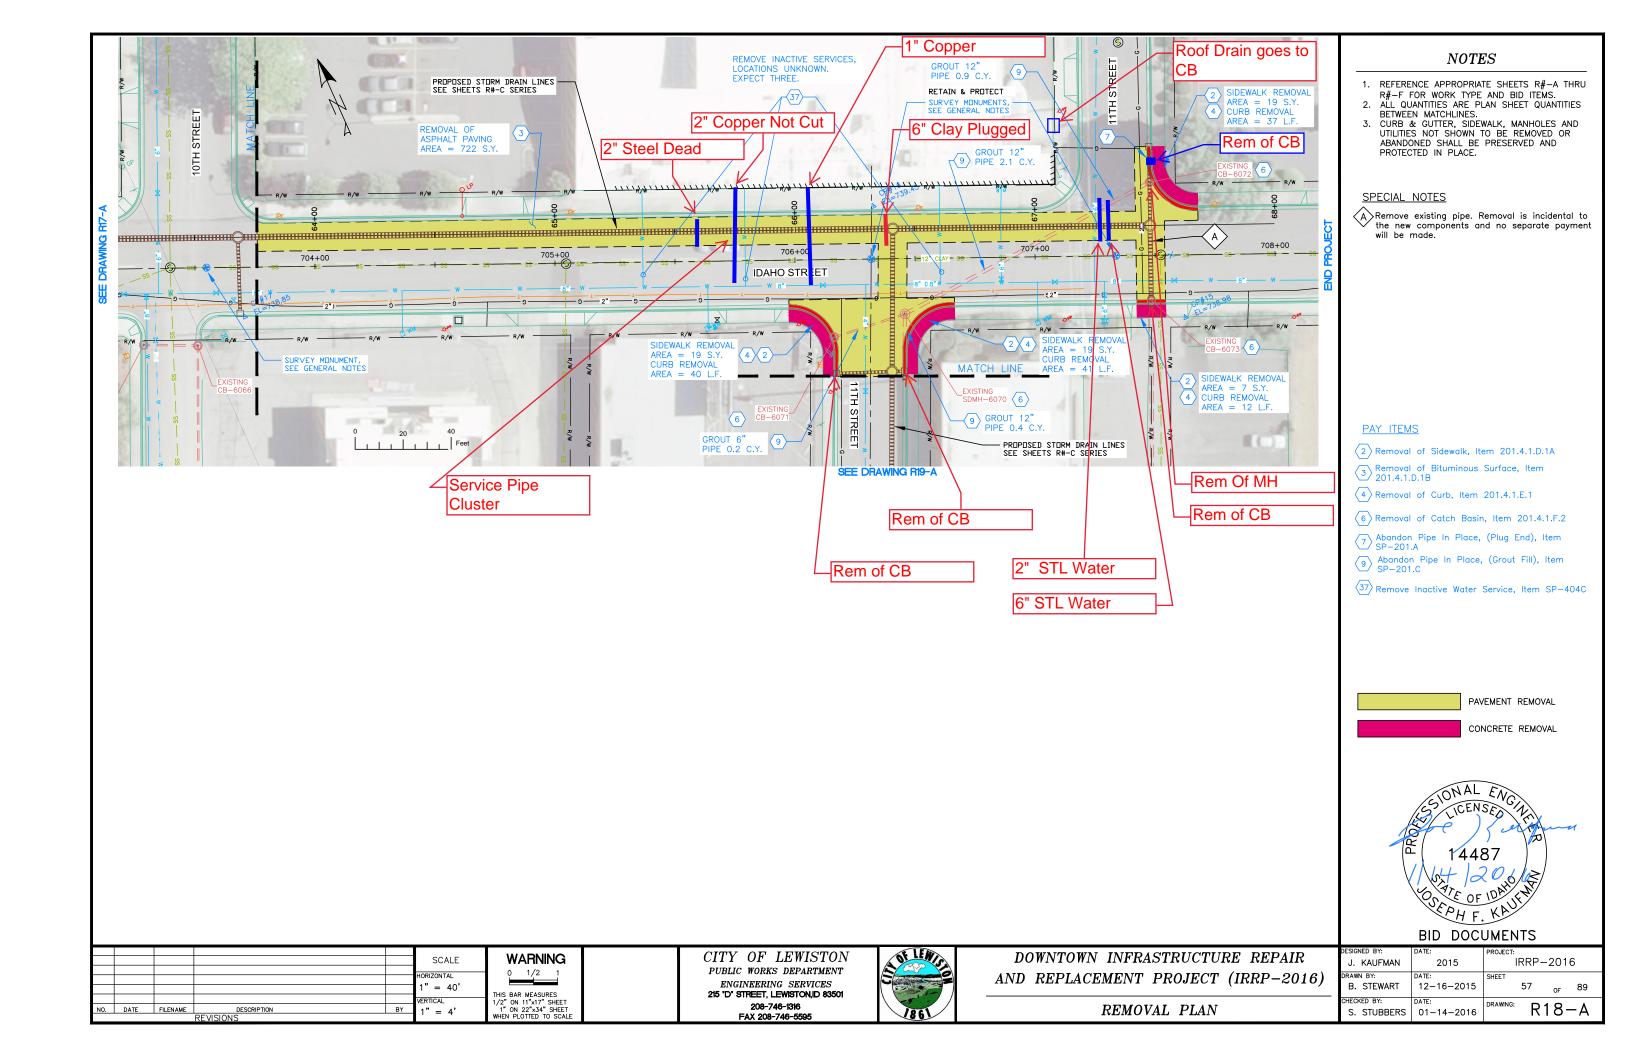

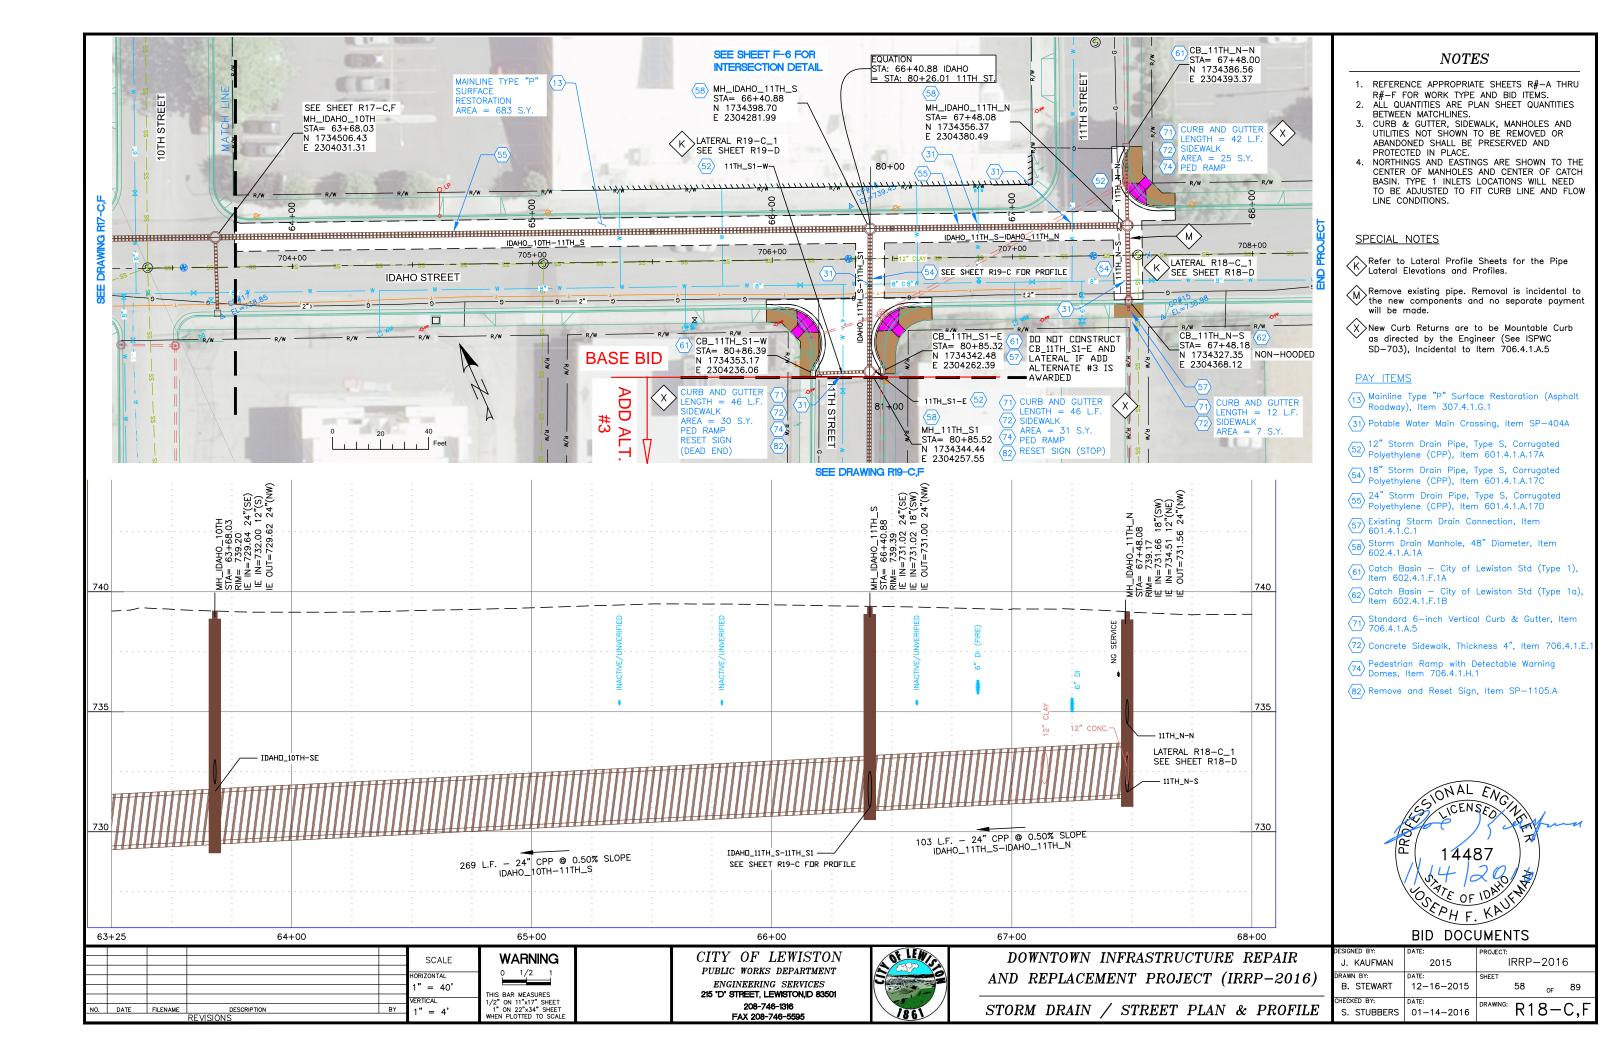

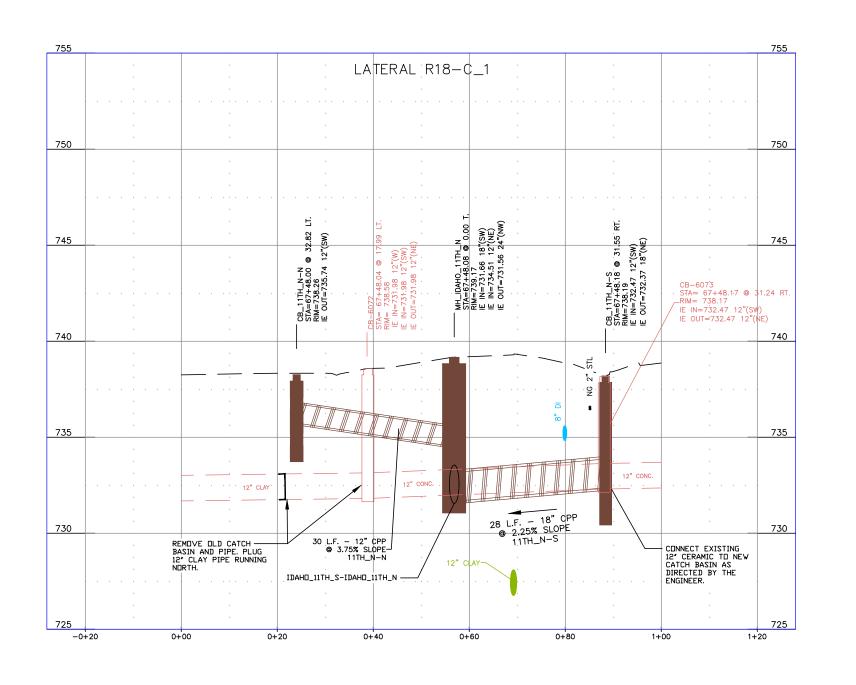



SCALE
HORIZONTAL
AS SHOWN
VERTICAL

WARNING

0 1/2 1

THIS BAR MEASURES
1/2" ON 11"x17" SHEET
1" ON 22"x34" SHEET
WHEN PLOTTED TO SCALE


AS SHOWN

CITY OF LEWISTON
PUBLIC WORKS DEPARTMENT
ENGINEERING SERVICES
215 'D' STREET, LEWISTON, ID 83501
208-746-4316
FAX 208-746-5595



DOWNTOWN INFRASTRUCTURE REPAIR
AND REPLACEMENT PROJECT (IRRP-2016)

	טום טום	DIVILITIES			
DESIGNED BY:	DATE:	PROJECT:			
J. KAUFMAN	2015	IRRP-2016			
DRAWN BY:	DATE:	SHEET			
B. STEWART	12-16-2015	59 _{OF} 89			
CHECKED BY:	DATE:	DRAWING: D 1 0 D			
S. STUBBERS	01-14-2016	R18-D			

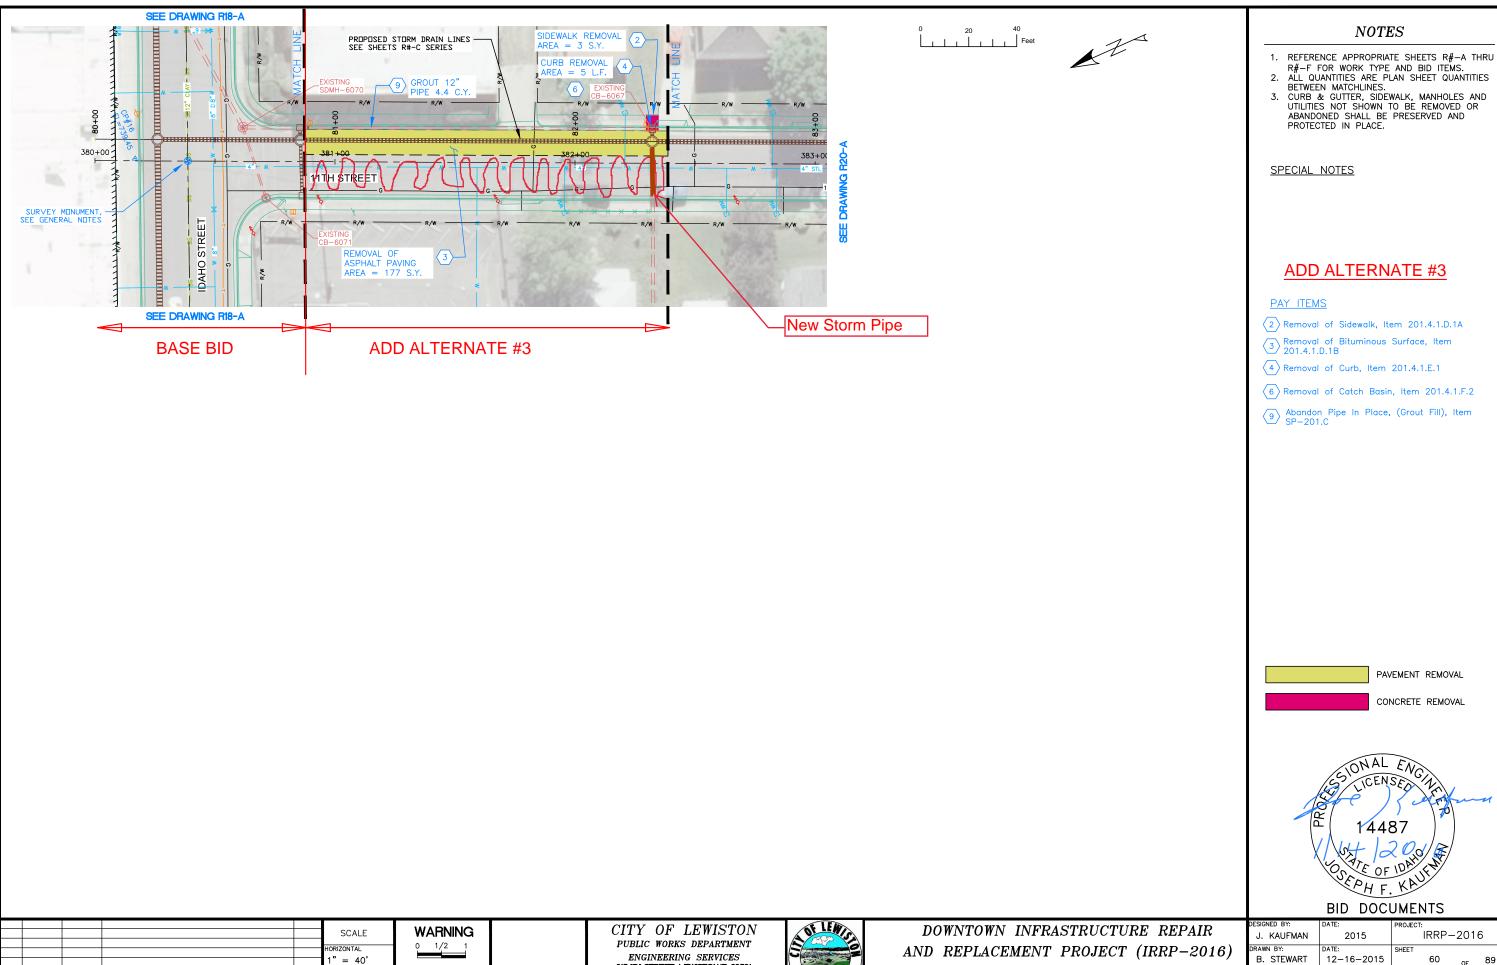

ENGINEERING SERVICES
215 "D" STREET, LEWISTON,ID 83501 208-746-1316 FAX 208-746-5595

THIS BAR MEASURES 1/2" ON 11"x17" SHEET 1" ON 22"x34" SHEET WHEN PLOTTED TO SCALE

VERTICAL

1" = 4'


NO. DATE FILENAME




AND REPLACEMENT PROJECT (IRRP-2016)

REMOVAL PLAN


DESIGNED BY:	DATE:	PROJECT:			
J. KAUFMAN	2015	l	RRP-	-201	6
DRAWN BY:	DATE:	SHEET			
B. STEWART	12-16-2015		60	OF	89
CHECKED BY:	DATE:	DRAWING:	$\overline{}$	10	
S. STUBBERS	01-14-2016		K	19	-A

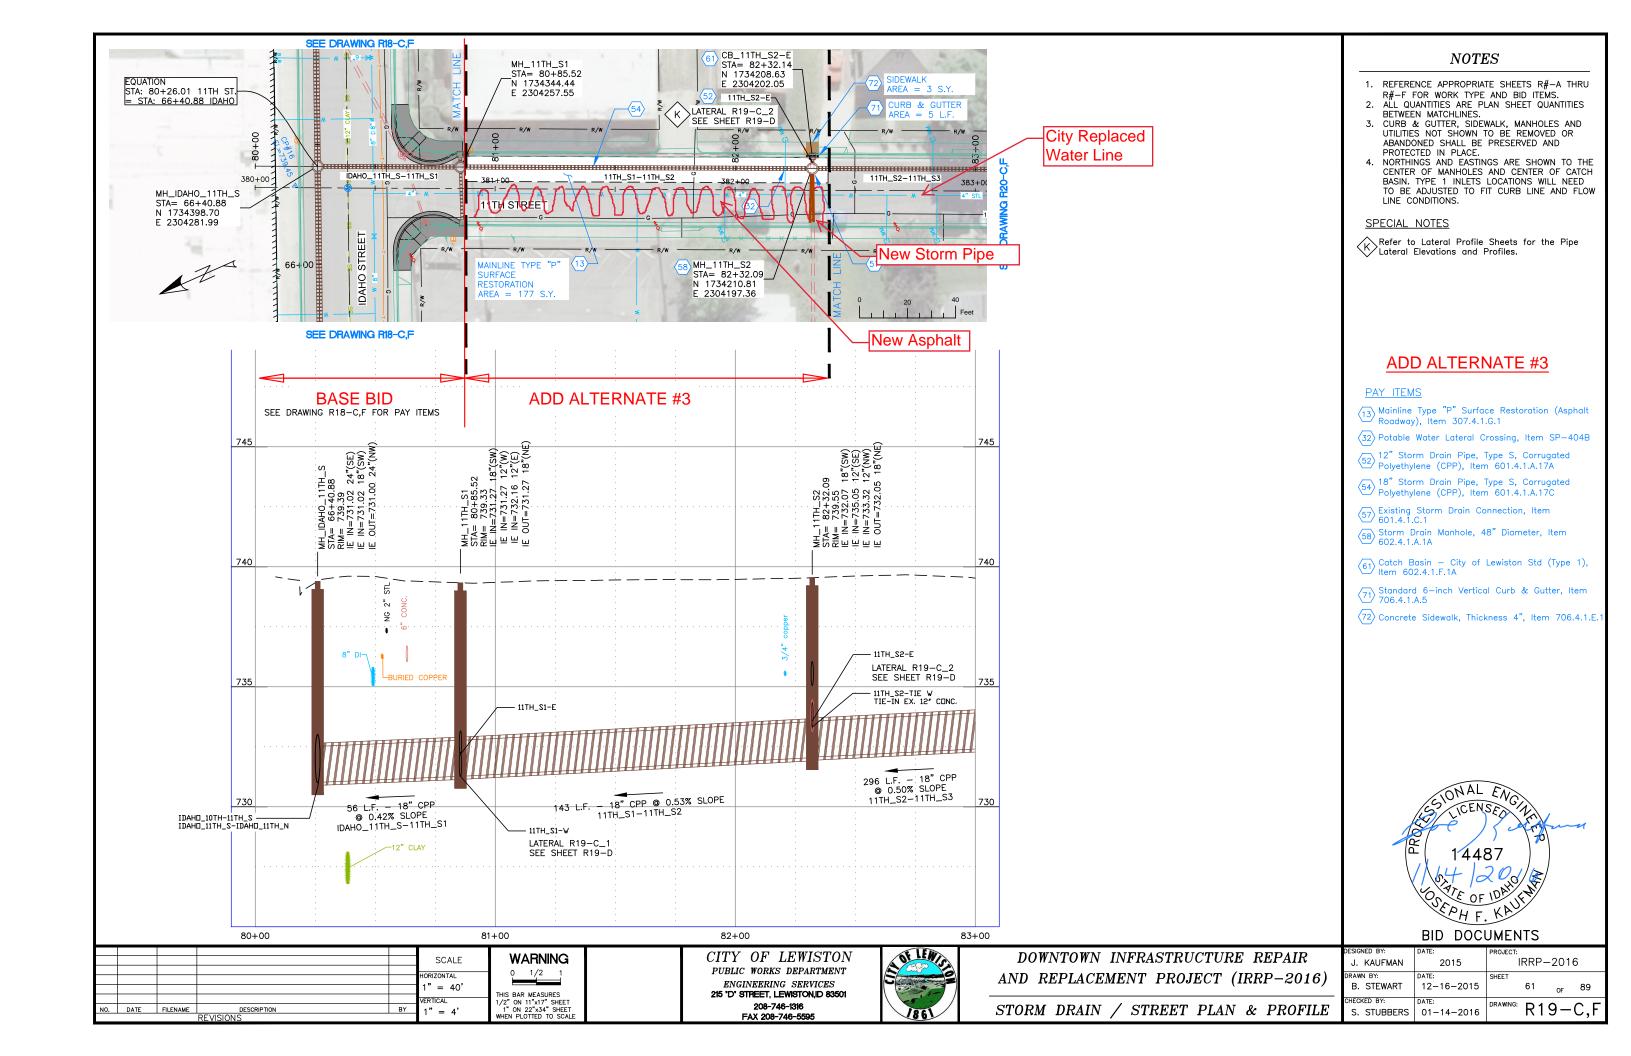


BASE BID

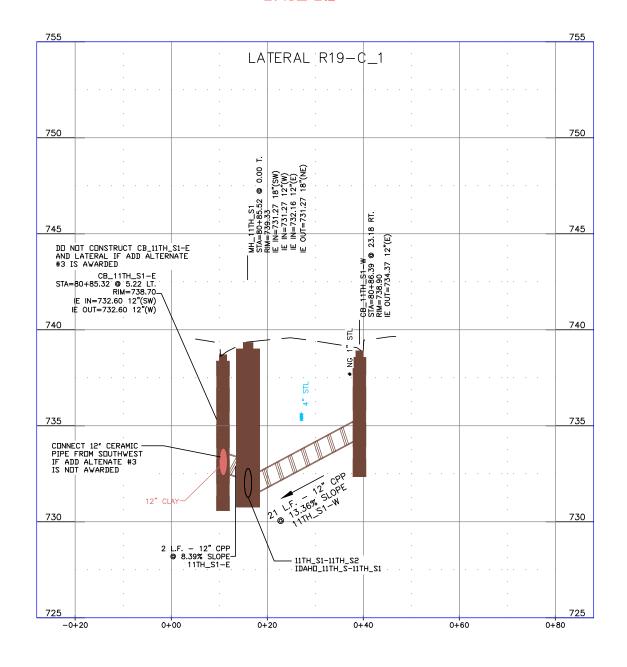

ADD ALTERNATE #3

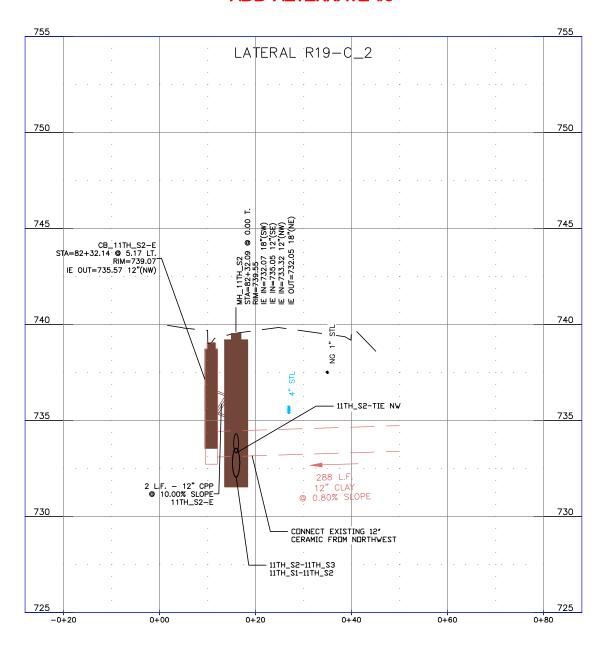

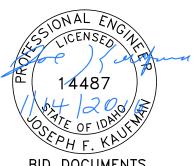

BID DOCUMENTS


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					HORIZONTAL AS SHOWN	0 1/2 1
NO.	DATE	FILENAME	DESCRIPTION	B.V.	VERTICAL AS SHOWN	THIS BAR MEASURES 1/2" ON 11"x17" SHEET 1" ON 22"x34" SHEET WHEN PLOTTED TO SCALE
			REVISIONS			WHEN TEOTIED TO SOME

CITY OF LEWISTON PUBLIC WORKS DEPARTMENT ENGINEERING SERVICES 215 'D' STREET, LEWISTON, ID 83501 FAX 208-746-5595



DOWNTOWN INFRASTRUCTURE REPAIR AND REPLACEMENT PROJECT (IRRP-2016)

DESIGNED BY:	DATE:	PROJECT:			
J. KAUFMAN	2015	l	RRP-	-201	6
DRAWN BY:	DATE:	SHEET			
B. STEWART	12-16-2015		62	OF	89
CHECKED BY:	DATE:	DRAWING:		4 0	
S. STUBBERS	01-14-2016		R	19	− <i>∪</i>

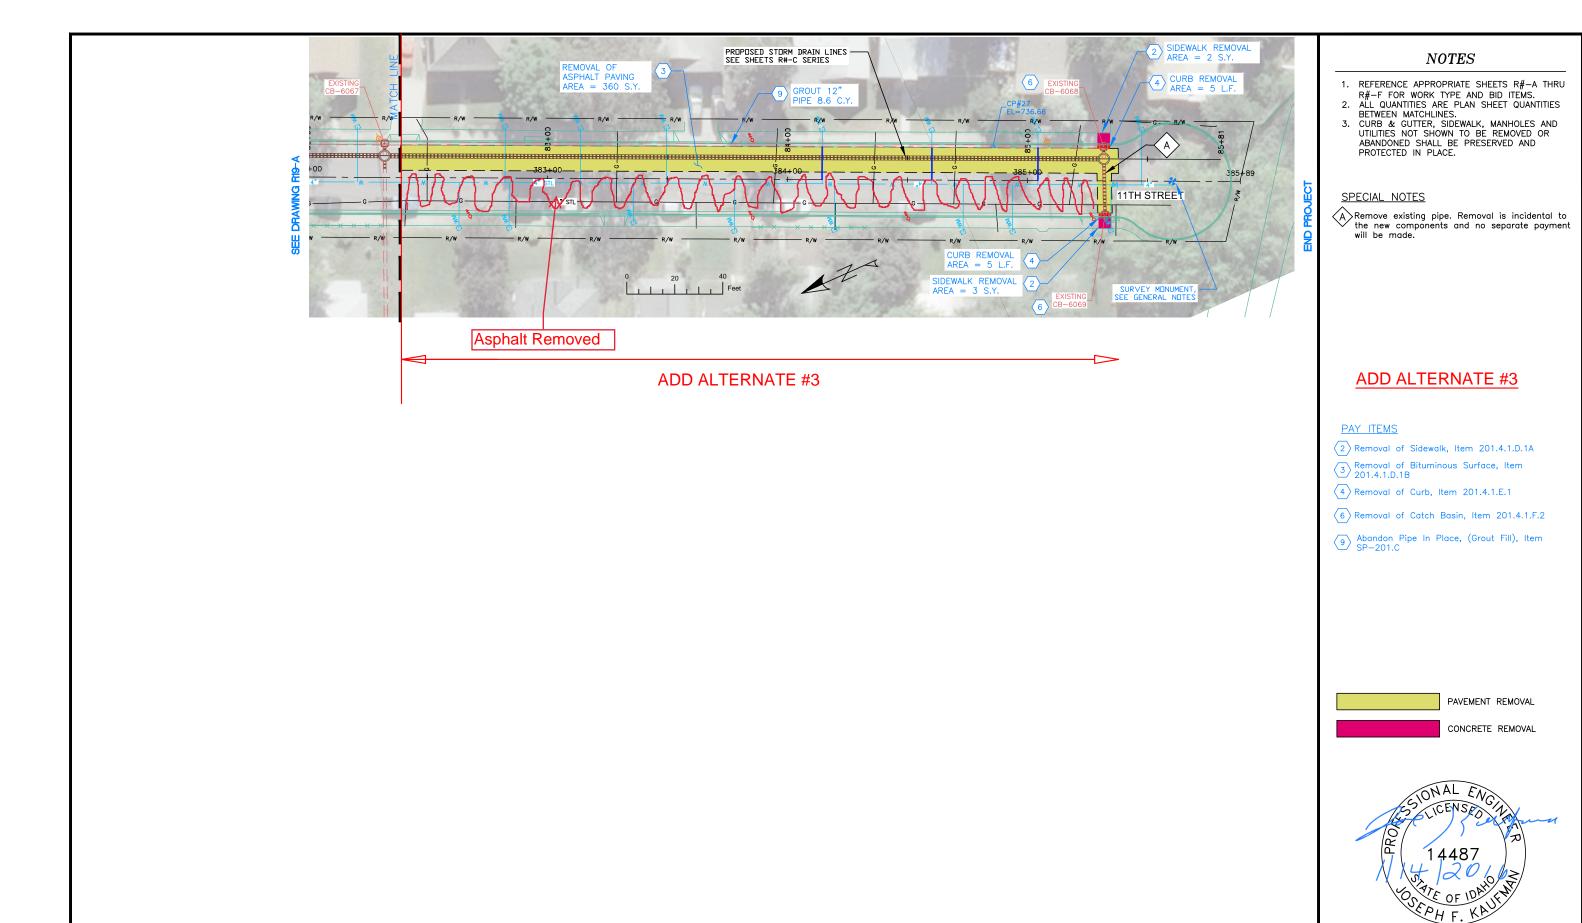

						\44 D\ \4	
					SCALE	Warning	
						0 1/2 1	
					HORIZONTAL	1,72	
					1" = 40'		
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NO.	DATE	FILENAME	DESCRIPTION	BY	1" - 4'	1" ON 22"x34" SHEET	
			DEVICIONS		1 - 4	WHEN PLOTTED TO SCALE	


CITY OF LEWISTON
PUBLIC WORKS DEPARTMENT
ENGINEERING SERVICES
215 'D' STREET, LEWISTON,ID 83501
208-746-1316
FAX 208-746-5595




DOWNTOWN INFRASTRUCTURE REPAIR
AND REPLACEMENT PROJECT (IRRP-2016)

REMOVAL PLAN

BID DOCUMENTS								
DESIGNED BY:	DATE:	PROJECT:						
J. KAUFMAN	2015	IRRP-2016						
DRAWN BY:	DATE:	SHEET						
B. STEWART	12-16-2015	63 _{OF} 89						
CHECKED BY: S. STUBBERS	DATE: 01-14-2016	DRAWING: R20-A						

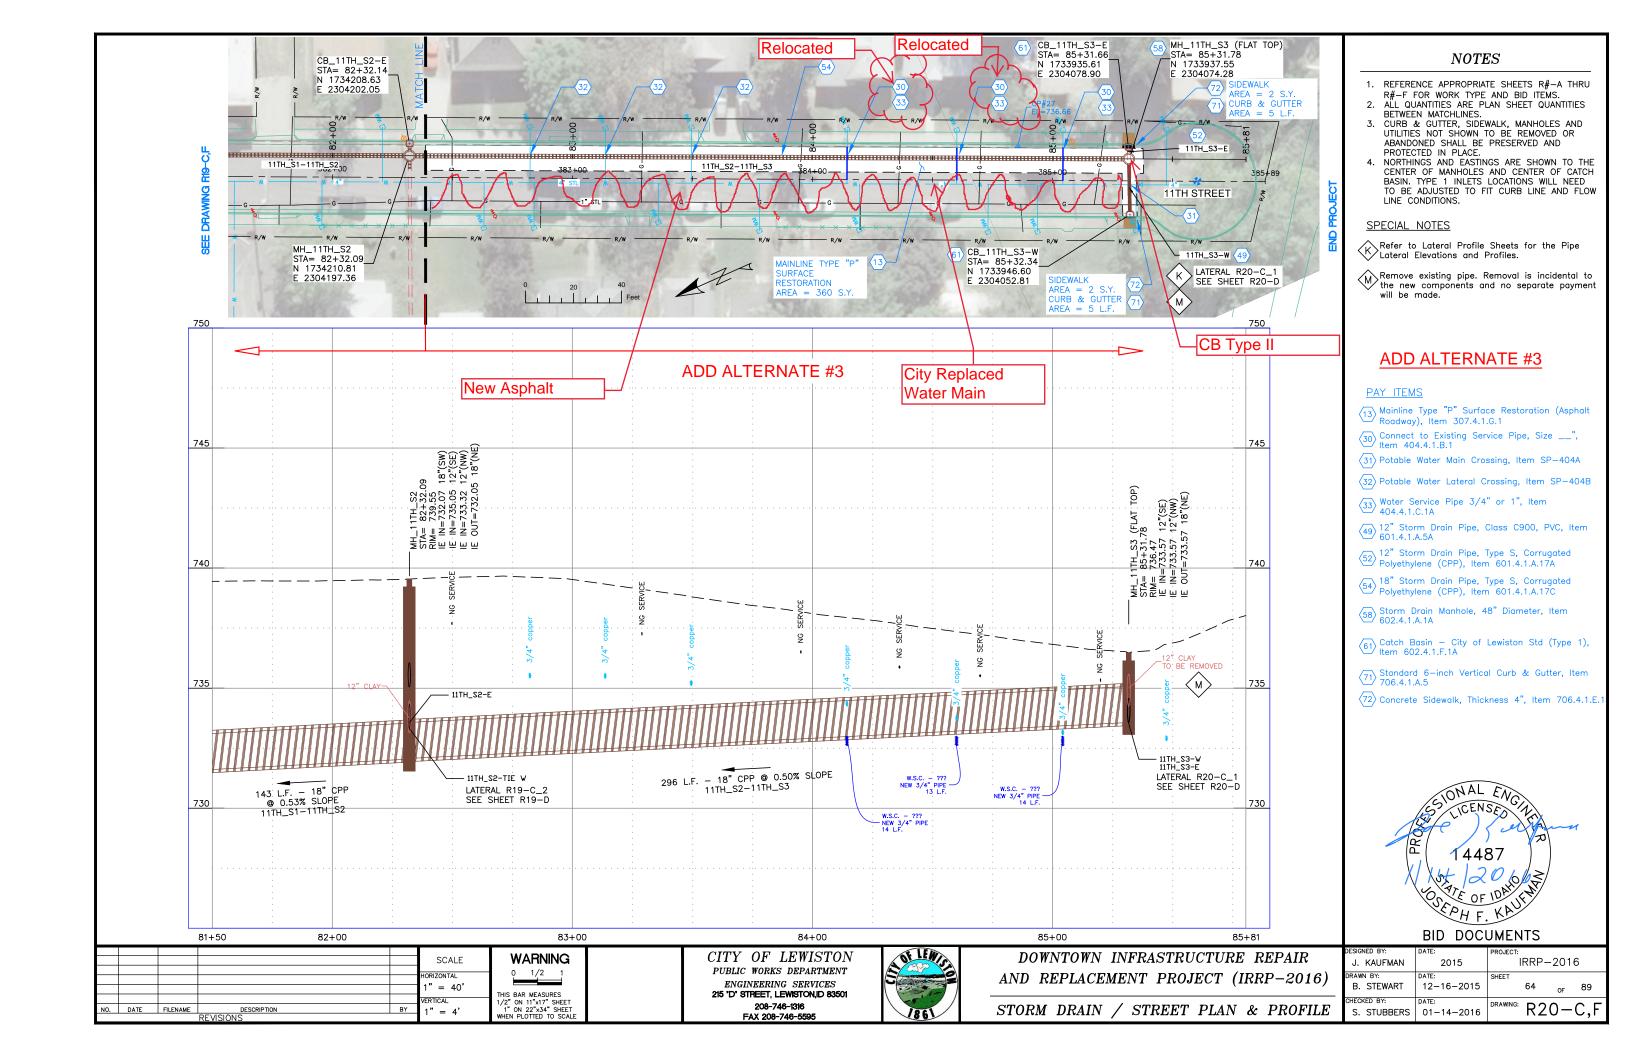

ADD ALTERNATE #3

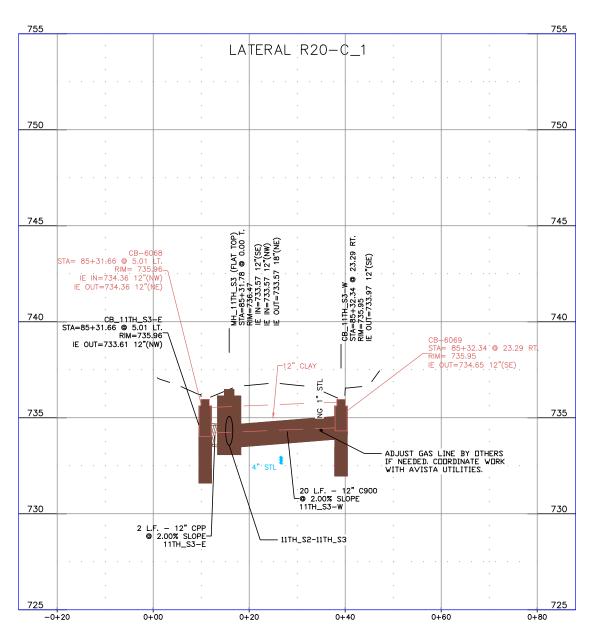



CITY OF LEWISTON DOWNTOWN INFRASTRUCTURE REPAIR **WARNING** SCALE


208-746-1316

PUBLIC WORKS DEPARTMENT 0 1/2 1 ENGINEERING SERVICES
215 'D' STREET, LEWISTON, ID 83501 AS SHOWN THIS BAR MEASURES 1/2" ON 11"x17" SHEET 1" ON 22"x34" SHEET WHEN PLOTTED TO SCALE VERTICAL AS SHOWN FAX 208-746-5595



AND REPLACEMENT PROJECT (IRRP-2016) STORM DRAIN LATERAL PROFILES

DESIGNED BY:	DATE:	PROJECT:					
J. KAUFMAN	2015	IRRP-2016					
DRAWN BY:	DATE:	SHEET					
B. STEWART	12-16-2015	65 _{OF} 89					
CHECKED BY:	DATE:	DRAWING: DOO D					
S. STUBBERS	01-14-2016	R20-D					

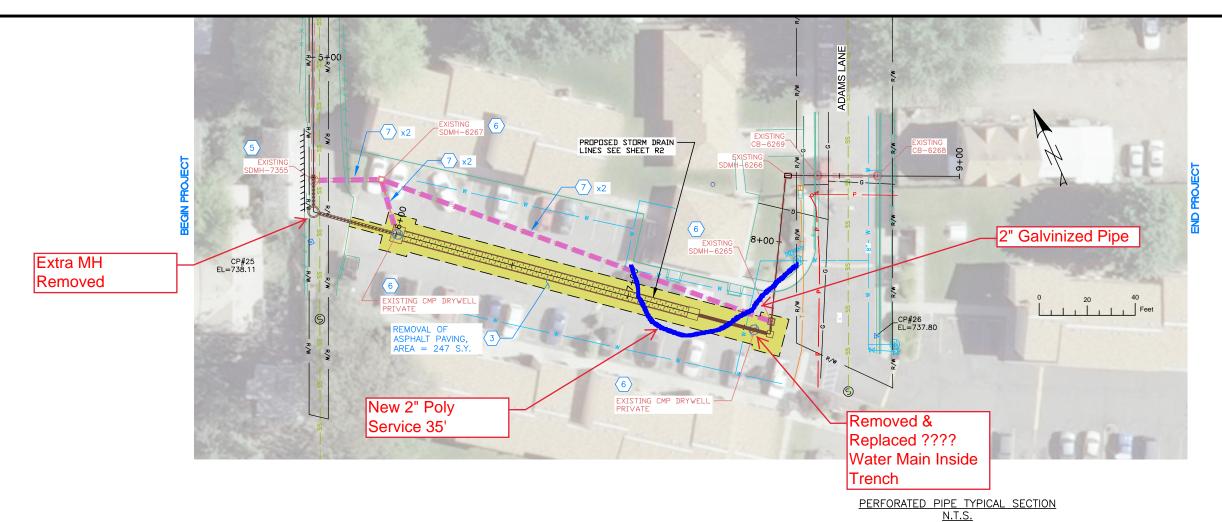

SPECIAL NOTE:

EXISTING SITE HAS A HIGH AMOUNT OF PEDESTRIAN TRAFFIC INCLUDING YOUNG CHILDREN. CONTRACTOR SHALL PAY SPECIAL ATTENTION TO KEEPING PEDESTRIANS AWAY FROM THE AREA DURING THE PROJECT AND SHALL HAVE TEMPORARY CHAIN LINK PANELS INSTALLED AT THE END OF THE DAY FOR ANY OPEN EXCAVATION.

Asphalt Compact Backfill 48 " Perforated Pipe Center In Trench Slope At 0% Wrap Trench Entirely With 6.0' Mn. Drain Rock Grand Water Or 18" Mm. Impermeable Layer

NOTES

- REFERENCE APPROPRIATE SHEETS R#-A THRU
- R#-F FOR WORK TYPE AND BID ITEMS.

 2. ALL QUANTITIES ARE PLAN SHEET QUANTITIES BETWEEN MATCHLINES.
- CURB & GUTTER, SIDEWALK, MANHOLES AND UTILITIES NOT SHOWN TO BE REMOVED OR ABANDONED SHALL BE PRESERVED AND PROTECTED IN PLACE.

SPECIAL NOTES

ADD ALTERNATE #5

PAY ITEMS

- 5 Removal of Manhole, Item 201.4.1.F.1
- 6 Removal of Catch Basin, Item 201.4.1.F.2
- $\overline{7}$ Abandon Pipe In Place, (Plug End), Item SP-201.A

PAVEMENT REMOVAL



BID DOCUMENTS

DESIGNED BY:	DATE:	PROJECT:		
J. KAUFMAN	2015	IRRP-2016		
DRAWN BY:	DATE:	SHEET		
B. STEWART	12-16-2015	66 _{OF} 89		
CHECKED BY:	DATE:	DRAWING: DO 1 A		
S. STUBBERS	01-14-2016	R21-A		


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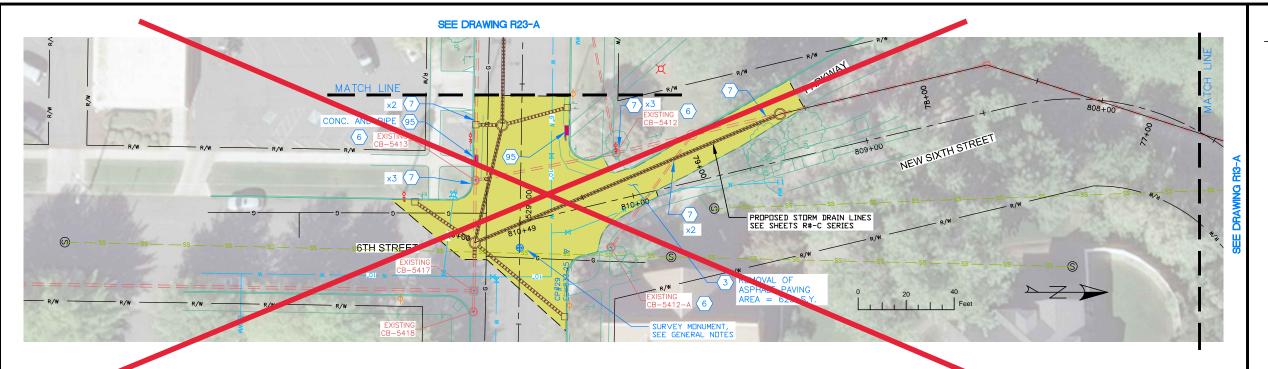
CITY OF LEWISTON PUBLIC WORKS DEPARTMENT ENGINEERING SERVICES
215 'D' STREET, LEWISTON, ID 83501 208-746-1316 FAX 208-746-5595



DOWNTOWN INFRASTRUCTURE REPAIR AND REPLACEMENT PROJECT (IRRP-2016)

REMOVAL PLAN



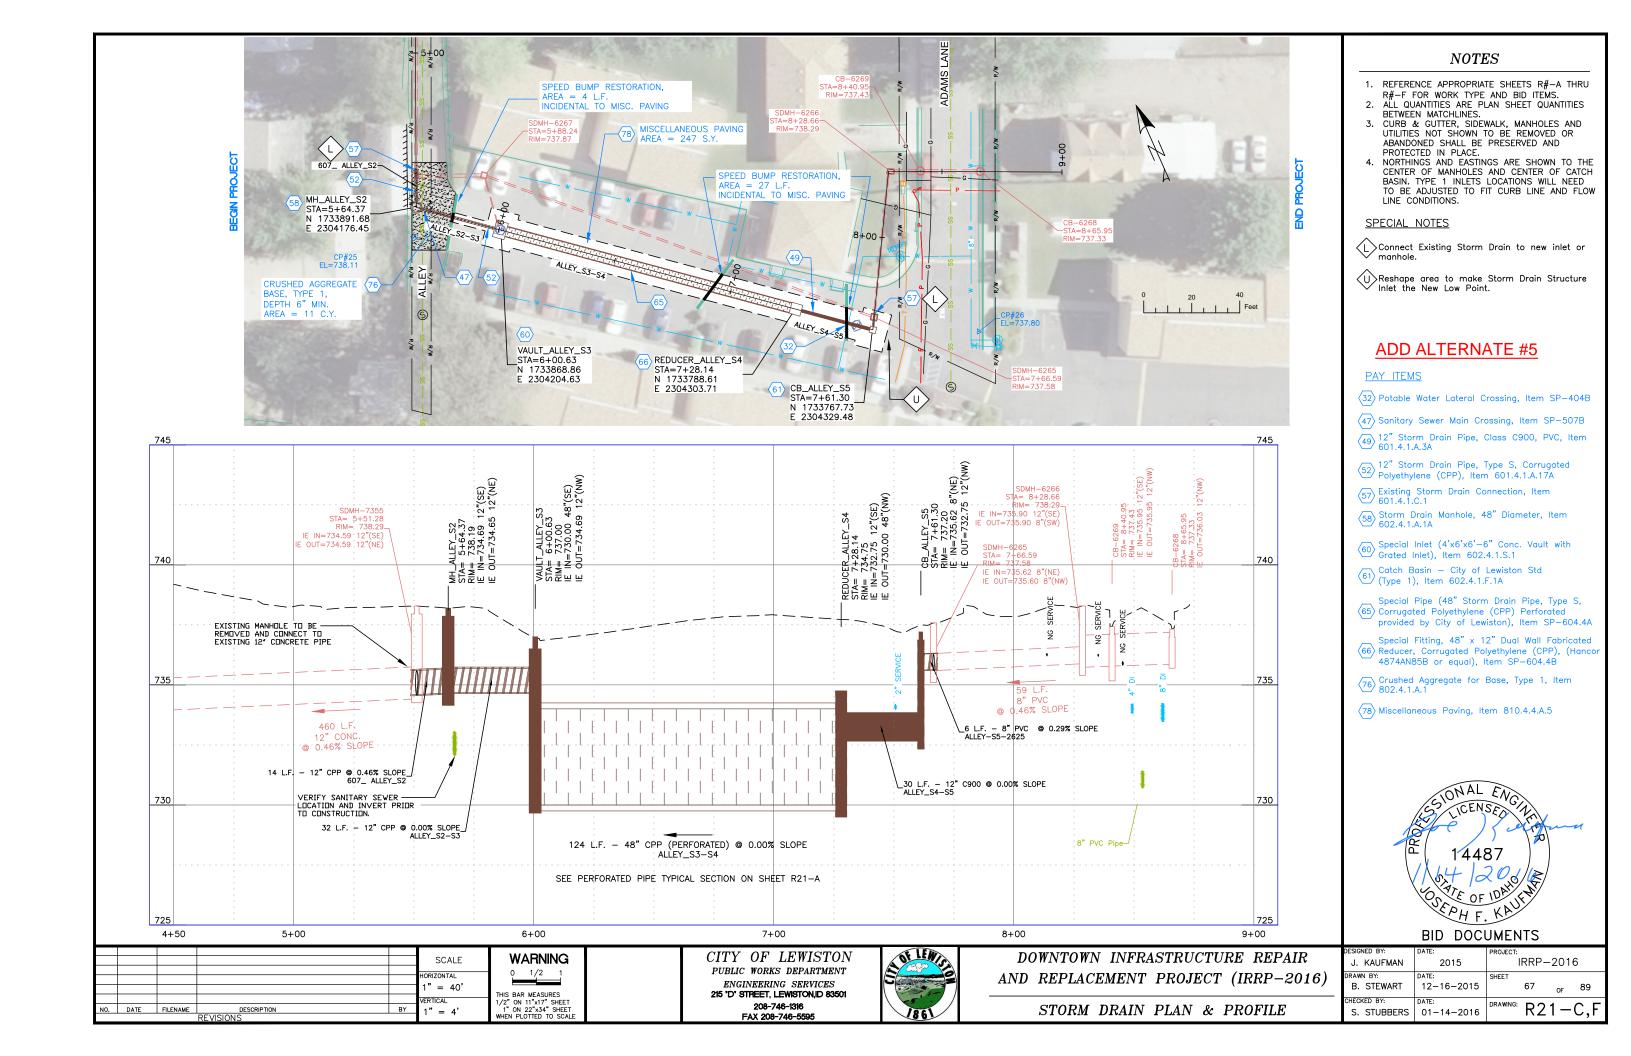

Did Not Do! Not Awarded!

NOTES

- REFERENCE APPROPRIATE SHEETS R#-A THRU R#-F FOR WORK TYPE AND BID ITEMS.
- ALL QUANTITIES ARE PLAN SHEET QUANTITIES BETWEEN MATCHLINES.
- CURB & GUTTER, SIDEWALK, MANHOLES AND UTILITIES NOT SHOWN TO BE REMOVED OR ABANDONED SHALL BE PRESERVED AND PROTECTED IN PLACE.

SPECIAL NOTES

ADD ALTERNATE #4

PAY ITEMS

- 6 Removal of Catch Basin, Item 201.4.1.F.2
- $\overline{7}$ Abandon Pipe In Place, (Plug End), Item SP-201.A
- 95 Removal of Obstruction, C.Y., Item 201.4.1.G.1

PAVEMENT REMOVAL

CONCRETE REMOVAL



BID DOCUMENTS

IRRP-2016 J. KAUFMAN 2015 B. STEWART 12-16-2015 68 R22-AS. STUBBERS | 01-14-2016

CITY OF LEWISTON PUBLIC WORKS DEPARTMENT ENGINEERING SERVICES 215 "D" STREET, LEWISTON ID 83501 208-746-1316

FAX 208-746-5595





DOWNTOWN INFRASTRUCTURE REPAIR AND REPLACEMENT PROJECT (IRRP-2016)


REMOVAL PLAN


SCALE						
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1" = 40'			\rightarrow			
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VERTICAL						
1" - 4'	BY	ESCRIPTION	1E	FILENAME	DATE	NO.


WARNING 1/2 1 THIS BAR MEASURES 1/2" ON 11"x17" SHEET 1" ON 22"x34" SHEET WHEN PLOTTED TO SCALE

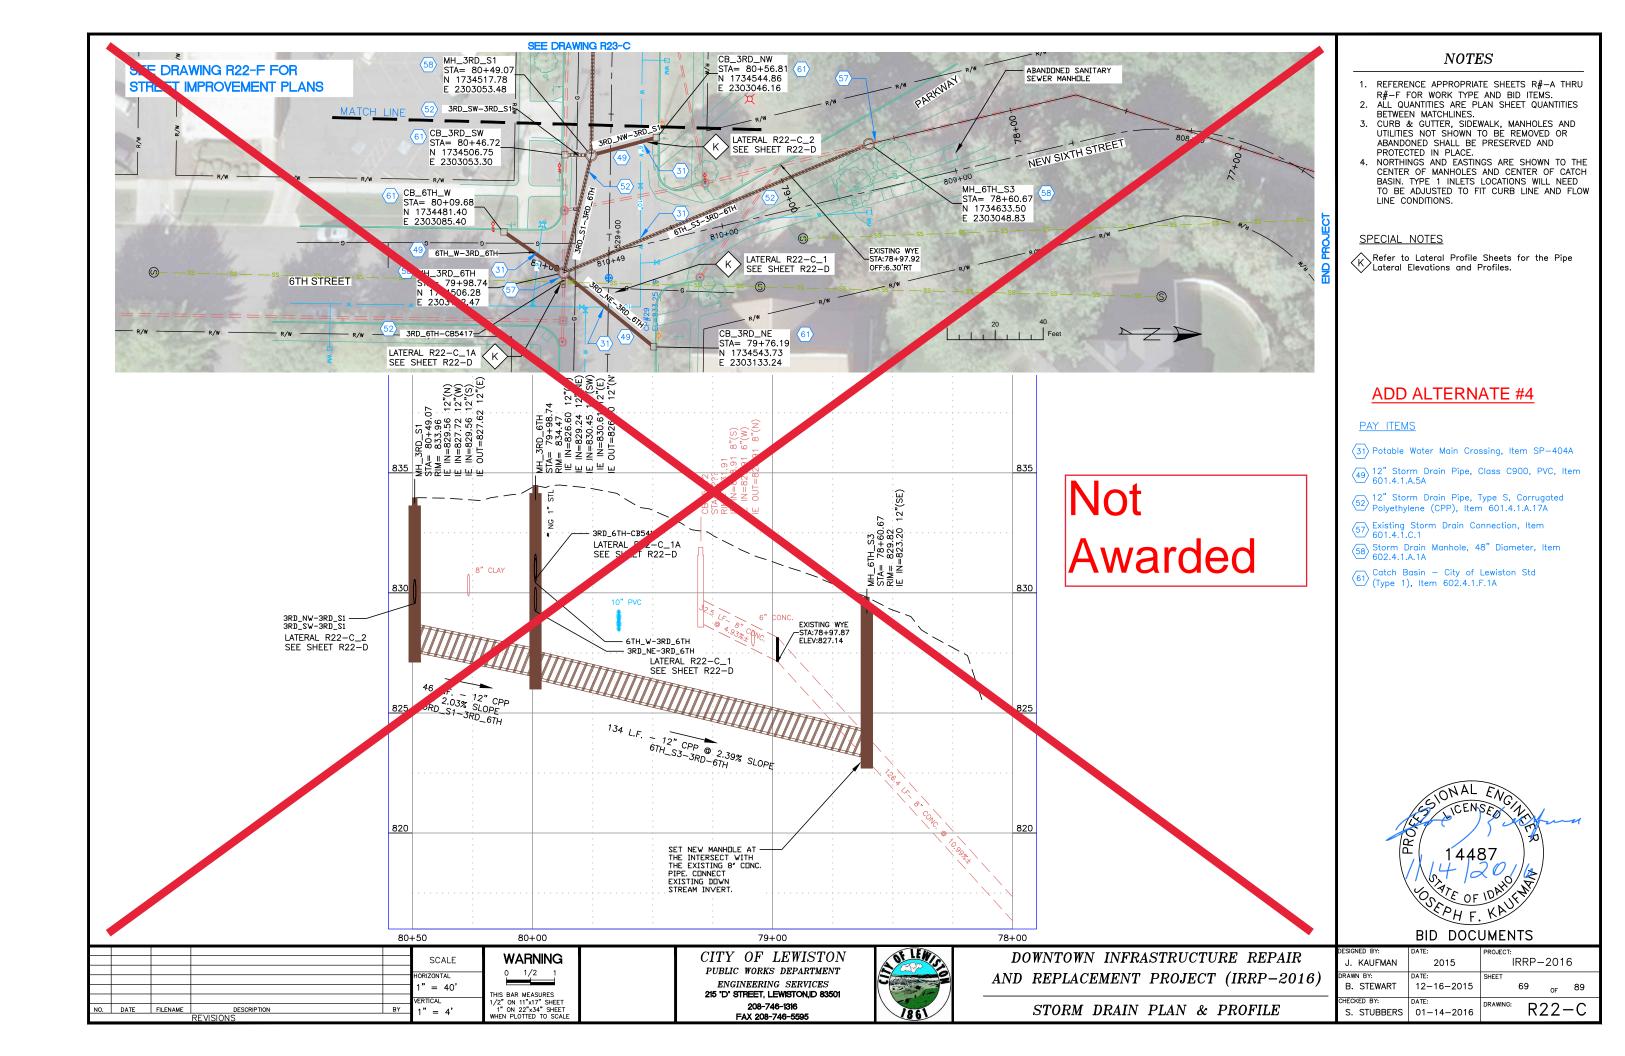


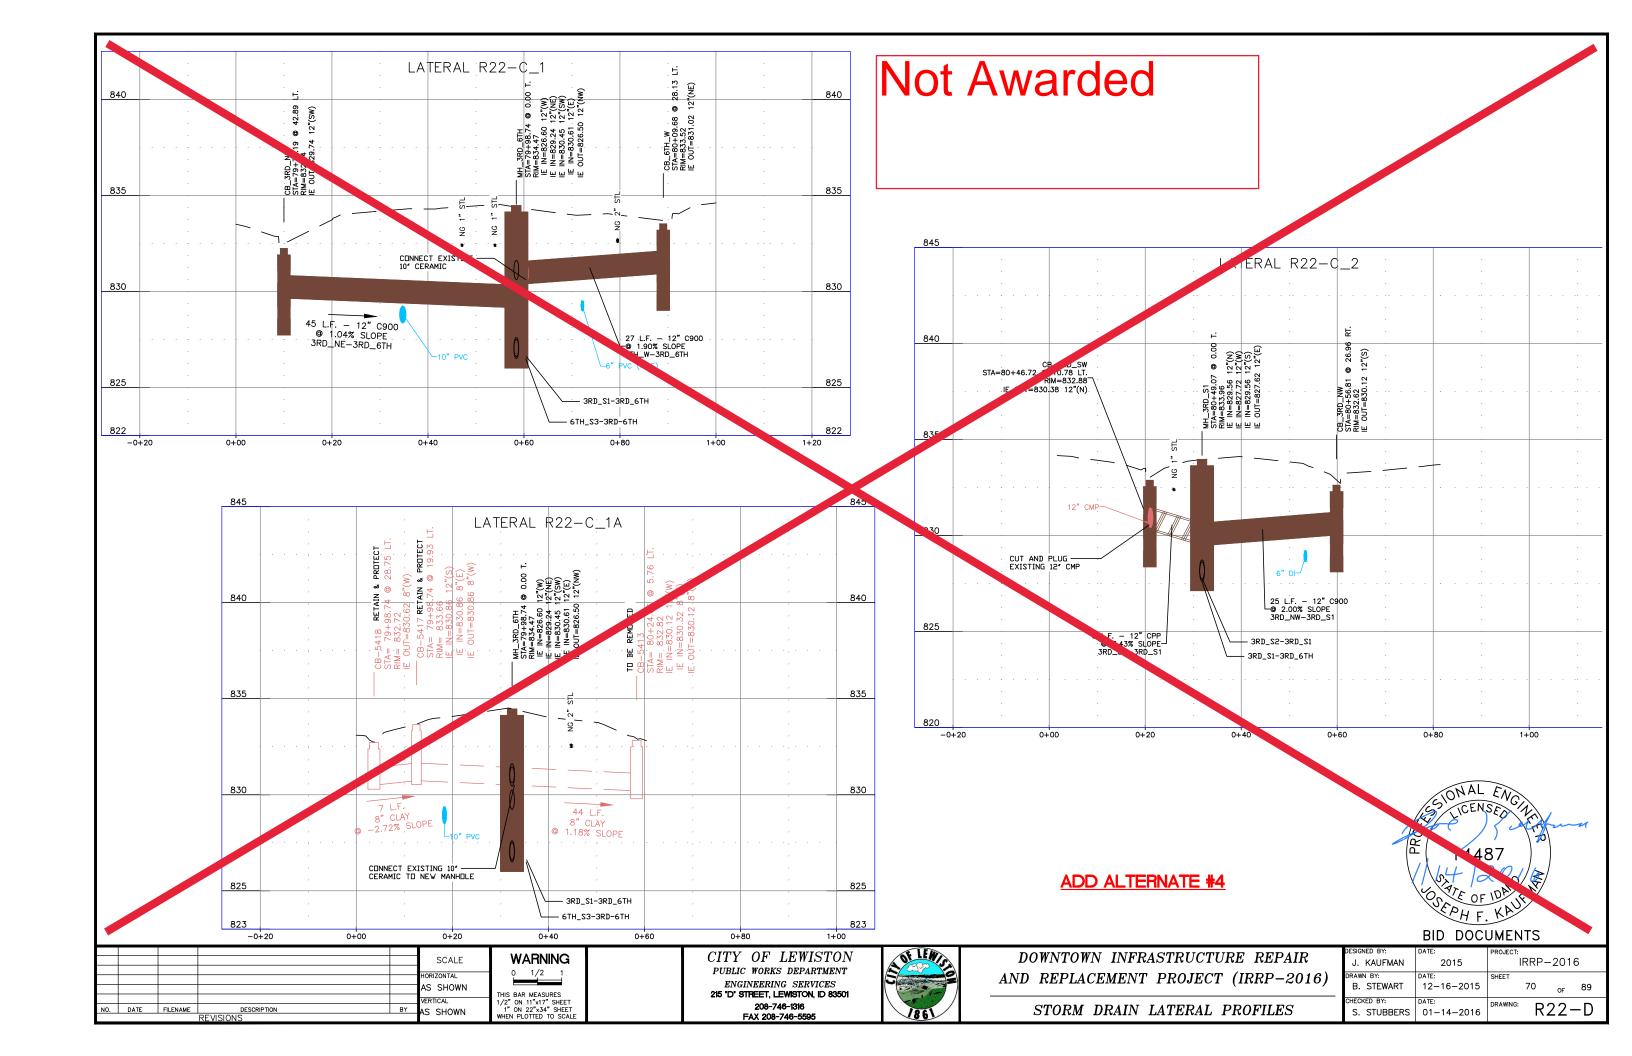


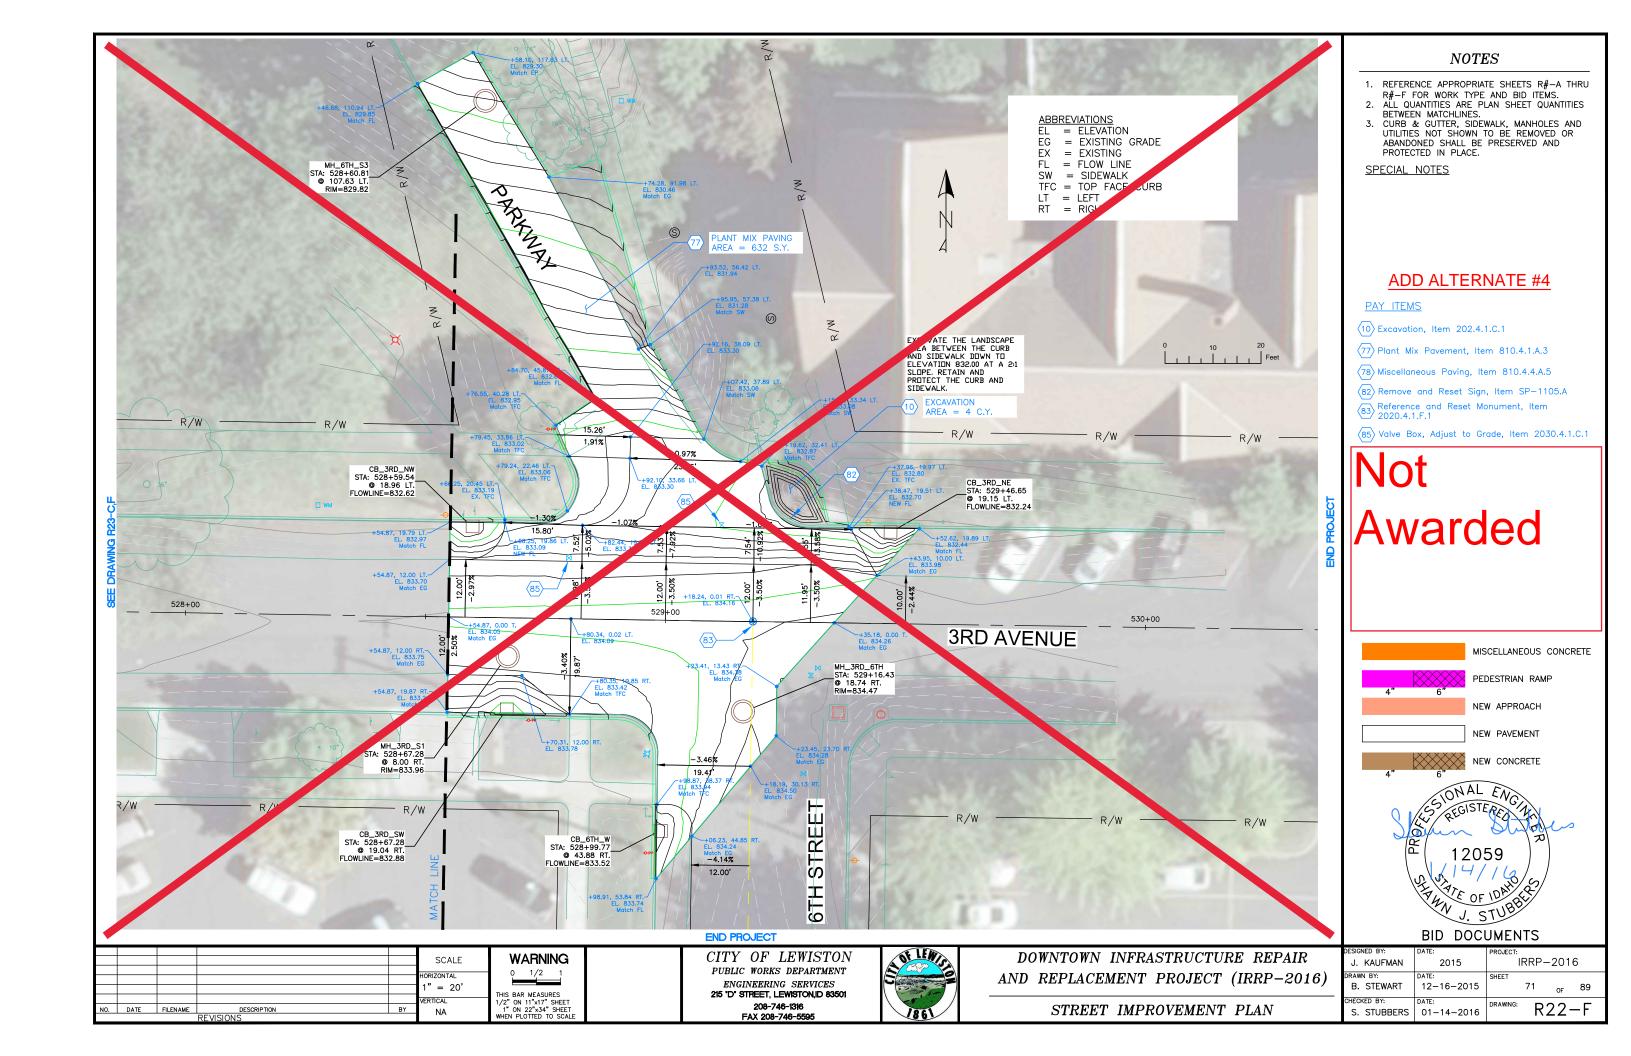


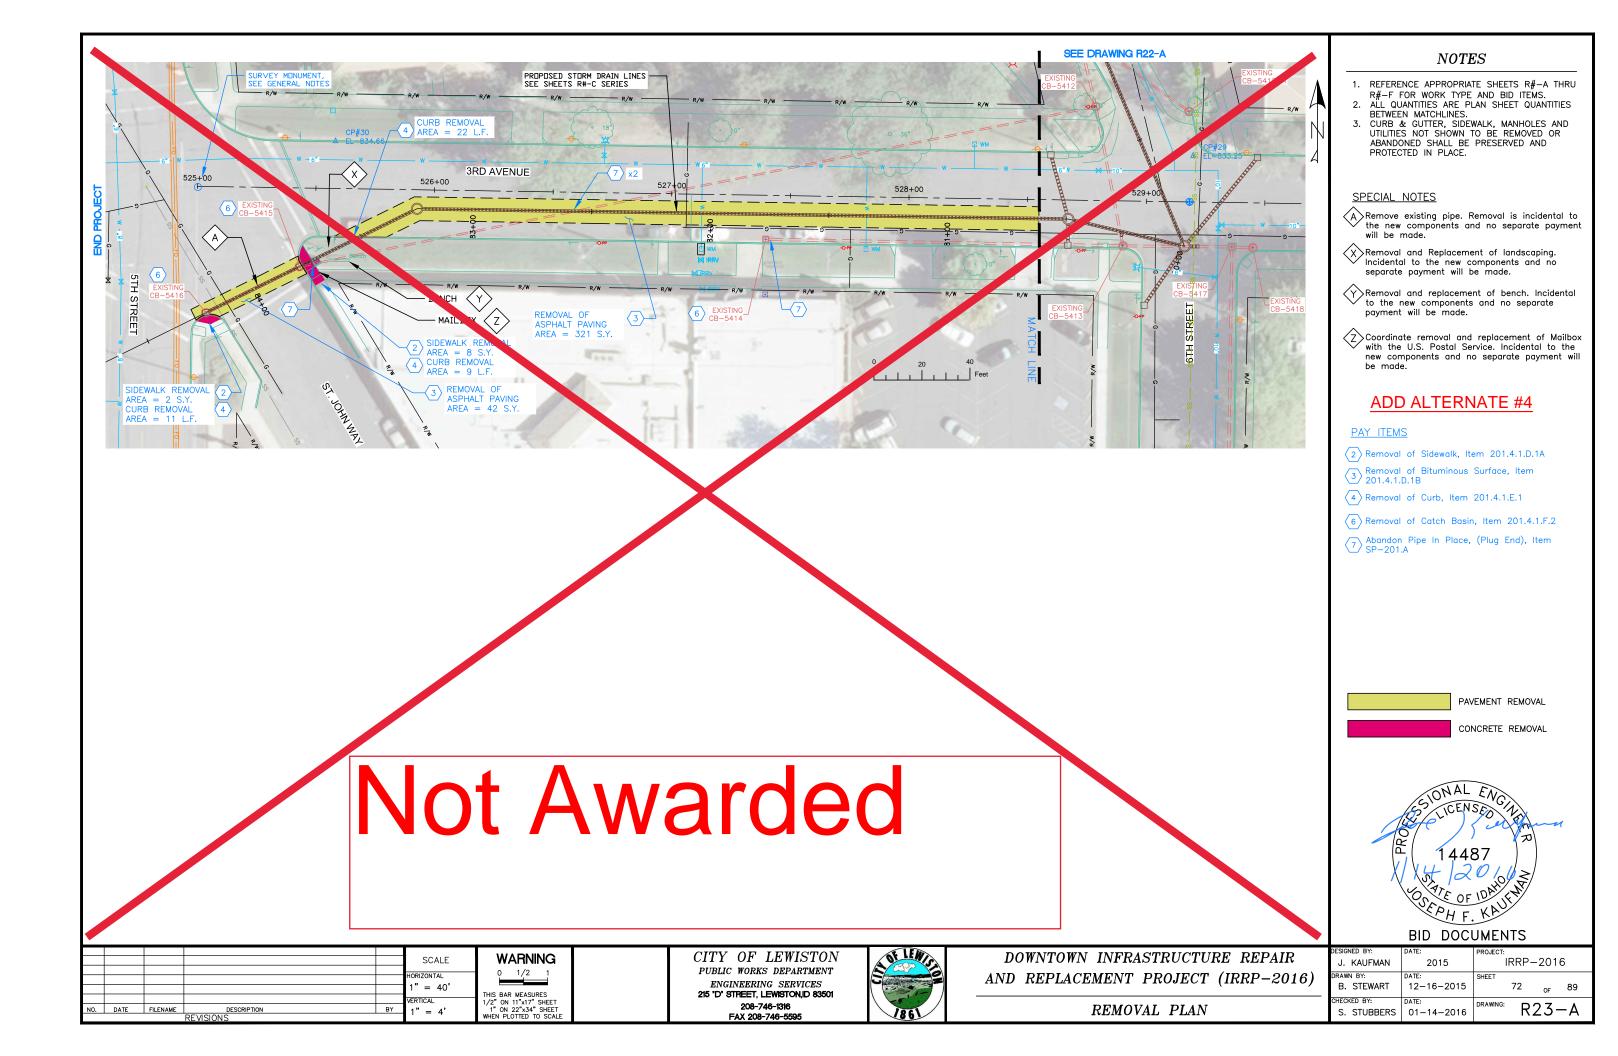

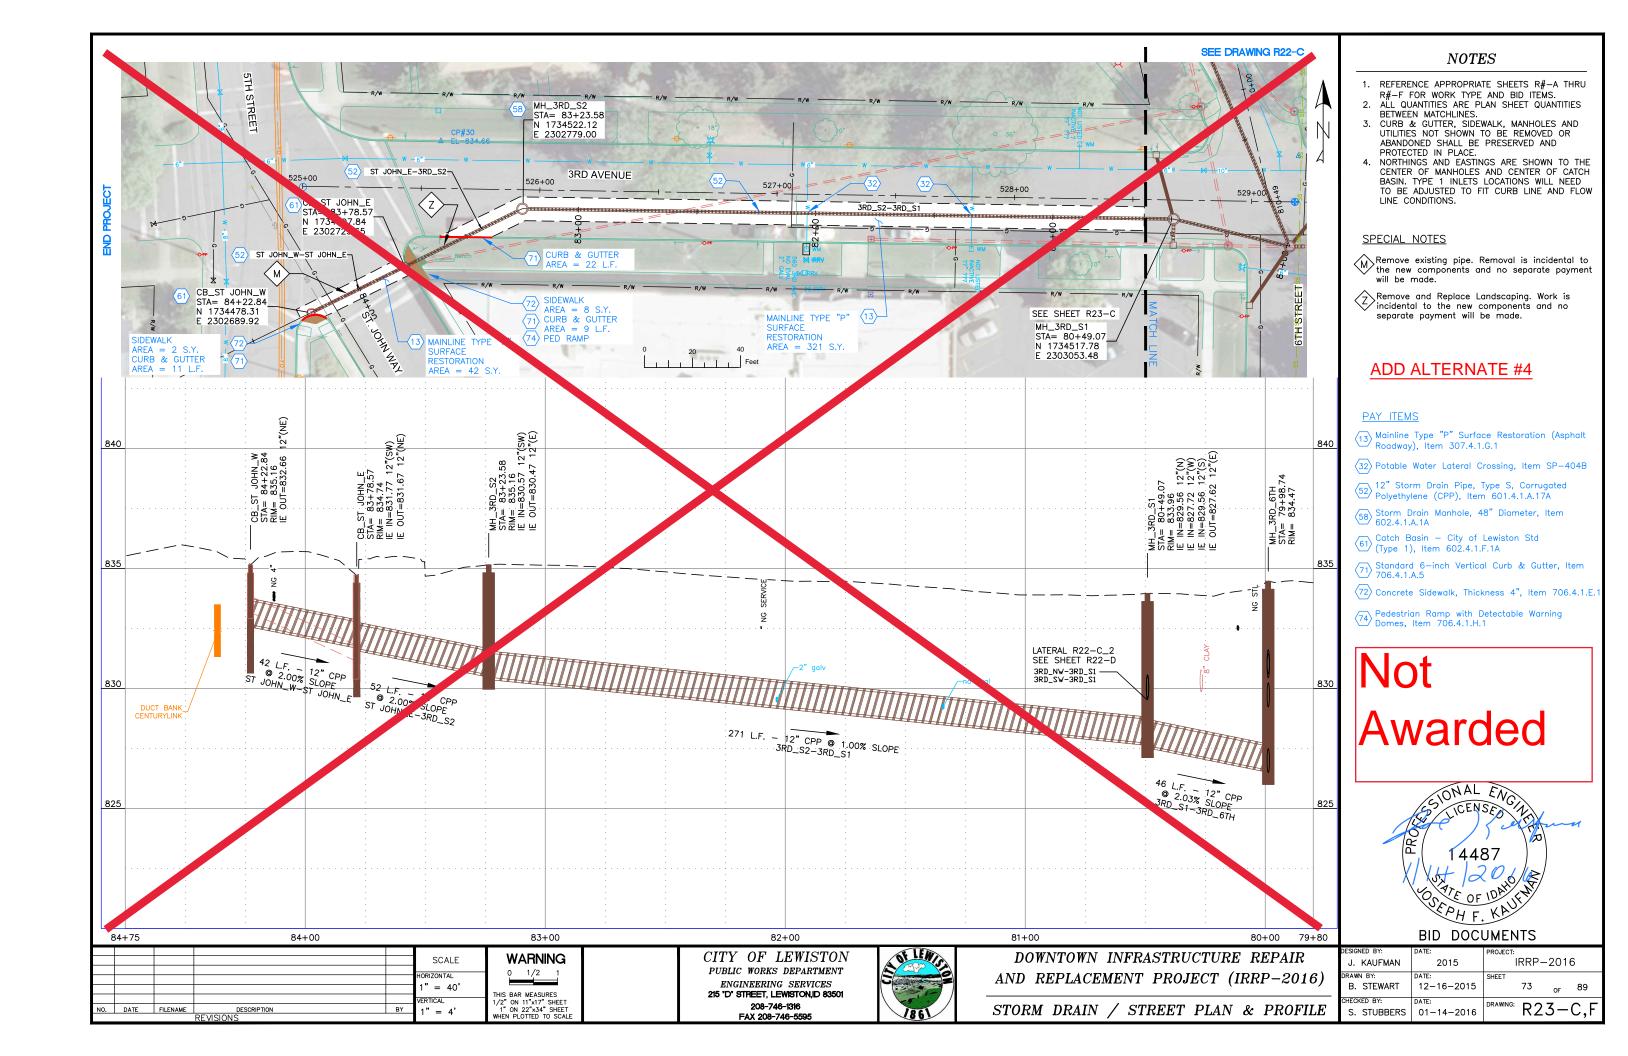


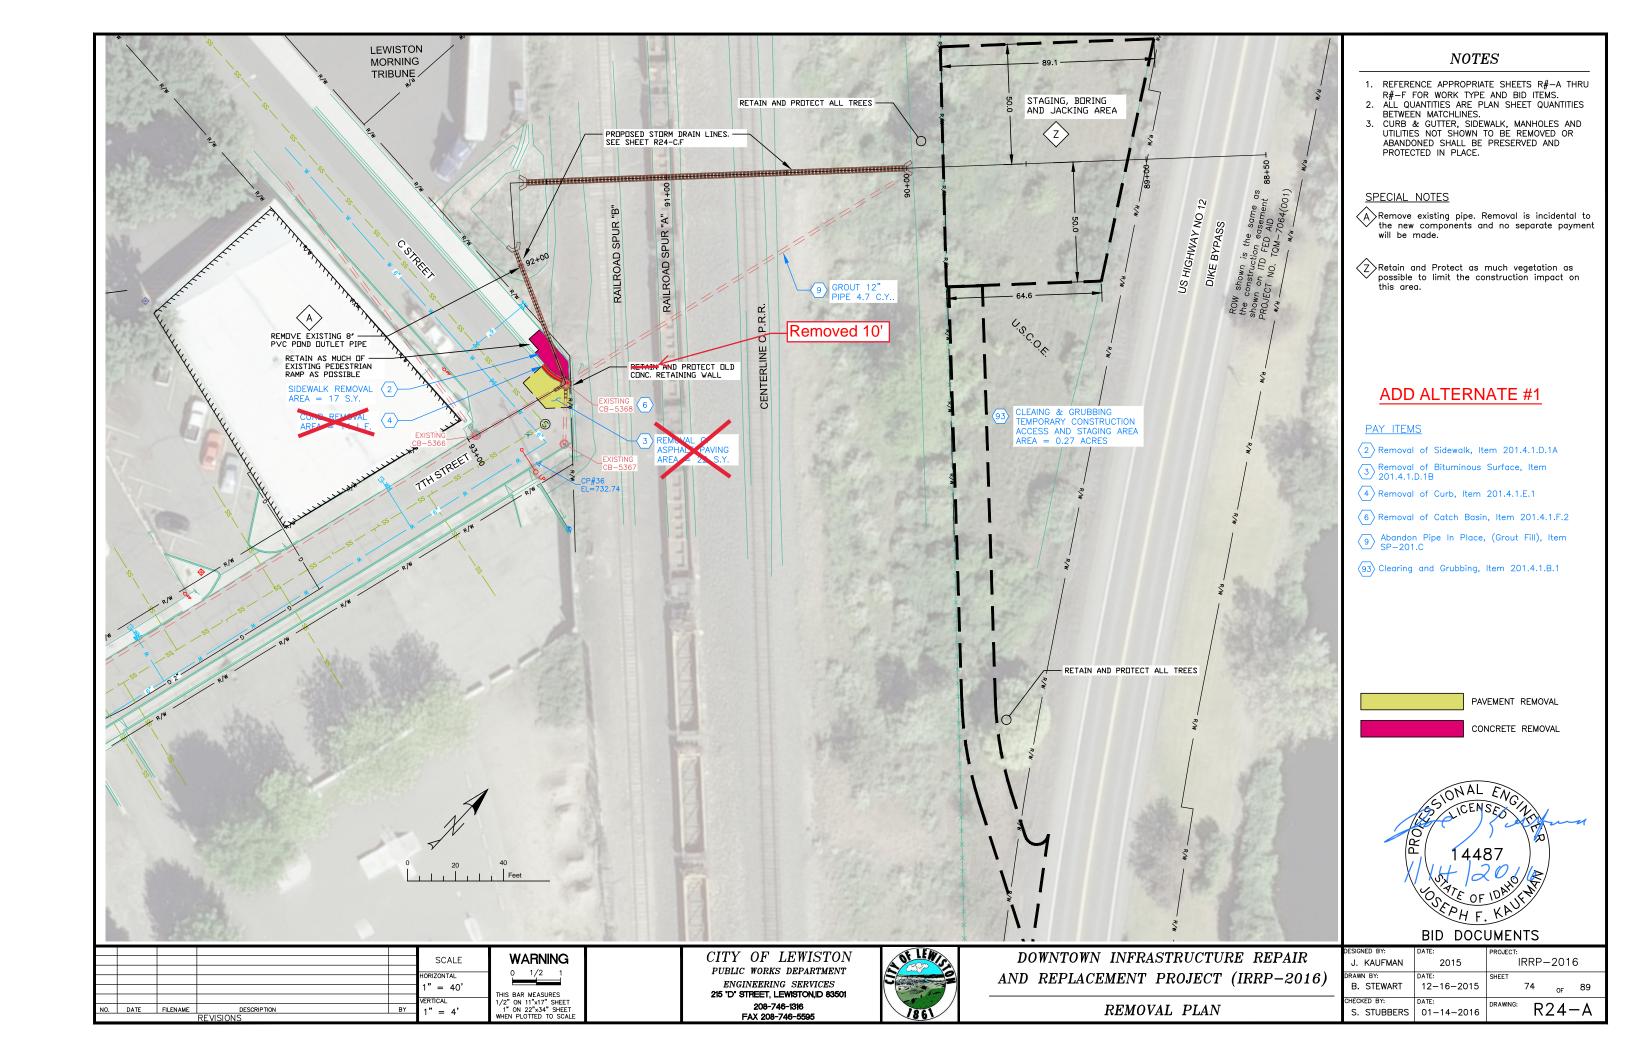

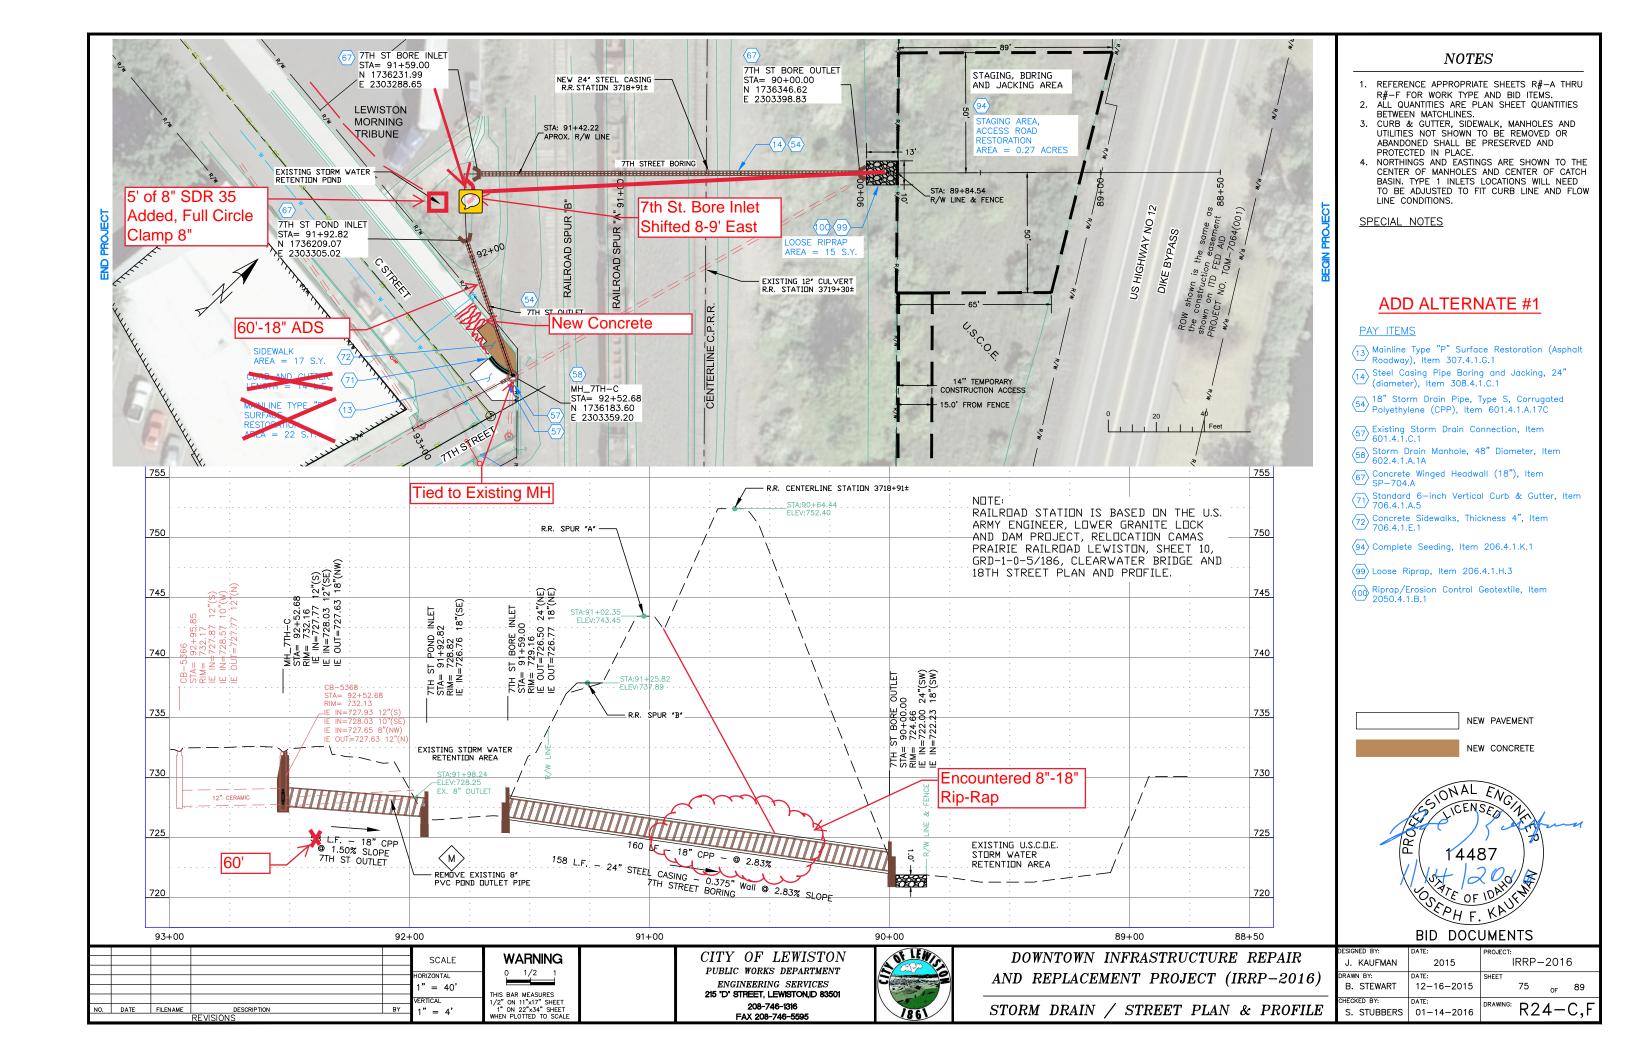

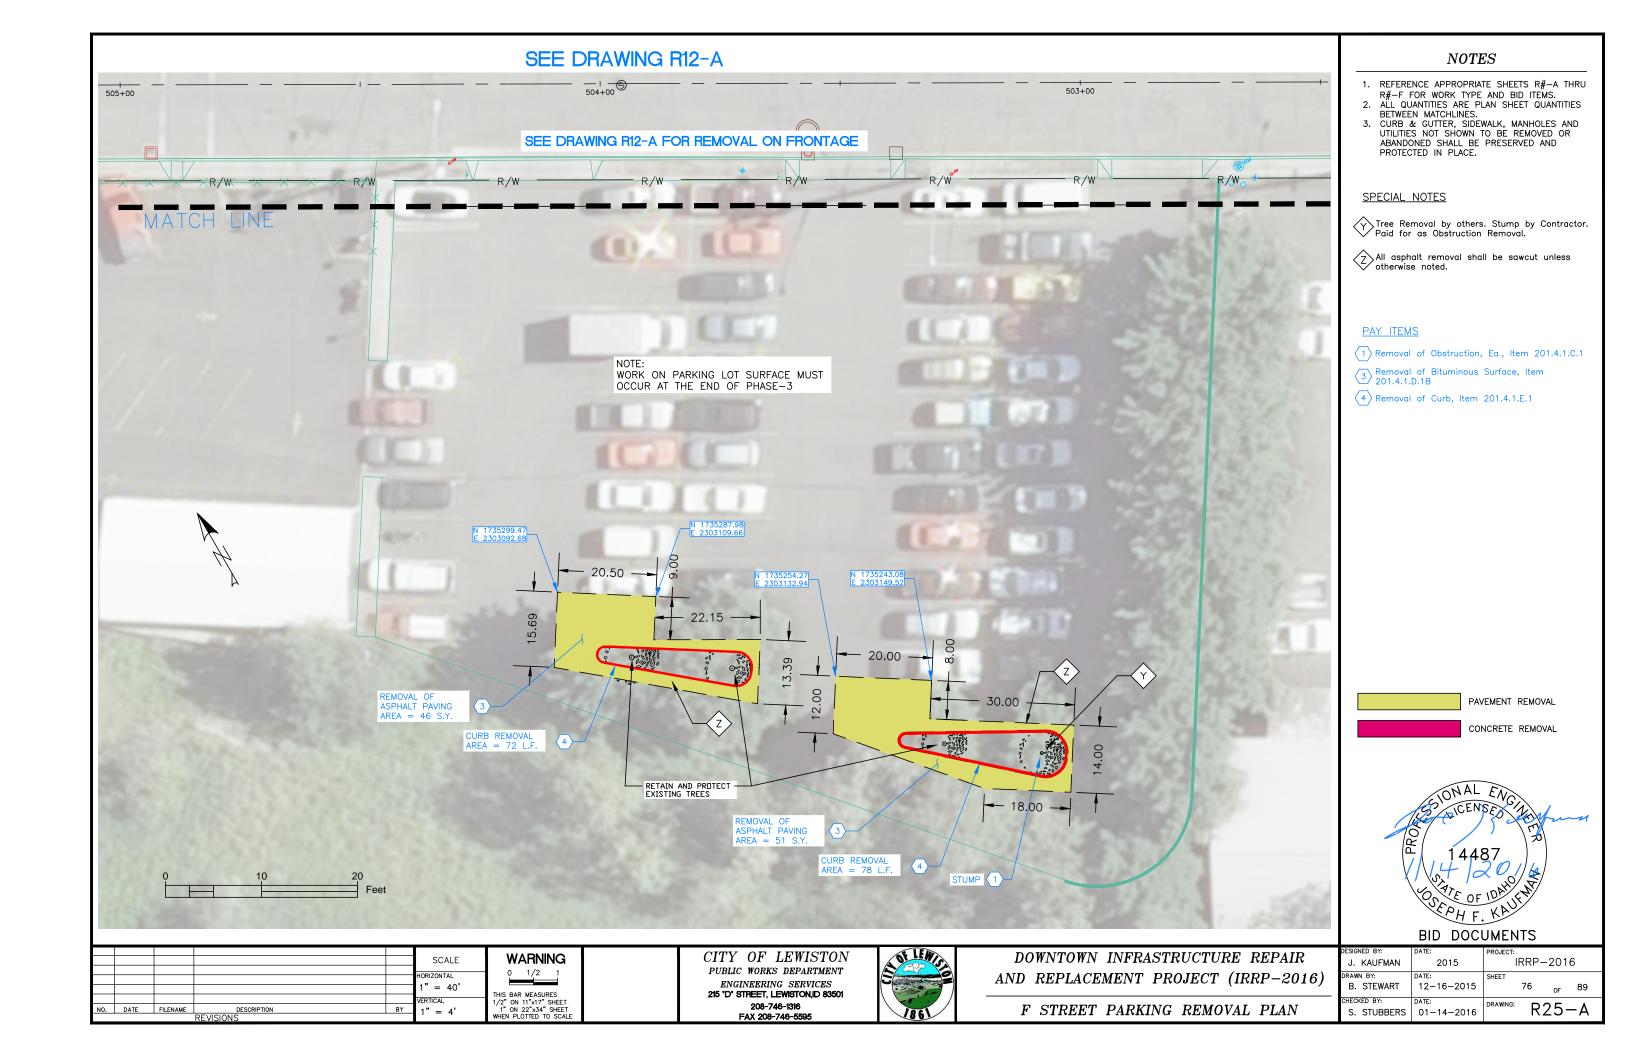

SEE DRAWING R12-F **NOTES** REFERENCE APPROPRIATE SHEETS R#-A THRU R#-F FOR WORK TYPE AND BID ITEMS. 2. ALL QUANTITIES ARE PLAN SHEET QUANTITIES BETWEEN MATCHLINES. SEE DRAWING R12-F FOR FRONTAGE IMPROVEMENTS 3. CURB & GUTTER, SIDEWALK, MANHOLES AND UTILITIES NOT SHOWN TO BE REMOVED OR ABANDONED SHALL BE PRESERVED AND PROTECTED IN PLACE. SPECIAL NOTES Z The 2" conduit has a minimum bury of 24 inches. Locating Wire and Marking Tape reauired. 89\90 2" CONDUIT - 165 L.F. (102)-BLUE PAINT, ADA STALLS Extra Repairs b/ of PAY ITEMS Existing Sink Holes (70) 6" Vertical Curb (No Gutter), Item 706.4.1.A.3 24.2 — 24.0 (78) Miscellaneous Paving, Item 810.4.4.A.5 BLUE ADA (80) Crack seal and Pavement Sealer, Item SP-810.B - 17.0 STANDARD STALLS 3 HC STALLS 81) Painted Pavement Marking, Item 1104.4.1.A.1 24.0 STALL 82 Remove and Reset Sign, Item SP-1105.A - 1.5 PAINTED PAVEMENT (89) Planter Bed Excavation, 42 C.Y., Item SP-221 2 0 0 AREA = 560 S.F. WHITE PAINT, (TYPICAL) \bigcirc Topsoil from Stockpile, Type S1, 42 C.Y., ltem SP-222 Conduit, Size 2" Diameter Schedule 40, Type PVC Item 1102.4.1.E.1 Extra Repairs b/ of Extra Repairs b/ of **Existing Sink Holes Existing Sink Holes** 61 0 - WHITE PAINT, (TYPICAL) 6 6 - EXISTING CURB LINE NEW LANDSCAPE AREA 24.0 MISCELLANEOUS CONCRETE PEDESTRIAN RAMP NEW APPROACH 19.0 -CRACK SEAL & PAVEMENT SEALER - 24.0 — NEW PAVEMENT AREA = 2,192 S.NEW CONCRETE 6" VERTICAL CURB AREA = 102 L.F. NEW PAVEMENT SEALER AREA = 24 S.Y.6" VERTICAL CURB AREA = 91 L.F. BID DOCUMENTS CITY OF LEWISTON DOWNTOWN INFRASTRUCTURE REPAIR WARNING SCALE IRRP-2016 J. KAUFMAN 2015 PUBLIC WORKS DEPARTMENT 0 1/2 1 AND REPLACEMENT PROJECT (IRRP-2016) ENGINEERING SERVICES 215 'D' STREET, LEWISTON,ID 83501 12-16-2015 77 B. STEWART 1" = 40'THIS BAR MEASURES 1/2" ON 11"x17" SHEET 1" ON 22"x34" SHEET WHEN PLOTTED TO SCALE VERTICAL 208-746-1316 R25-F NO. DATE FILENAME F STREET PARKING IMPROVEMENT PLAN S. STUBBERS 01-14-2016 1" = 4' FAX 208-746-5595

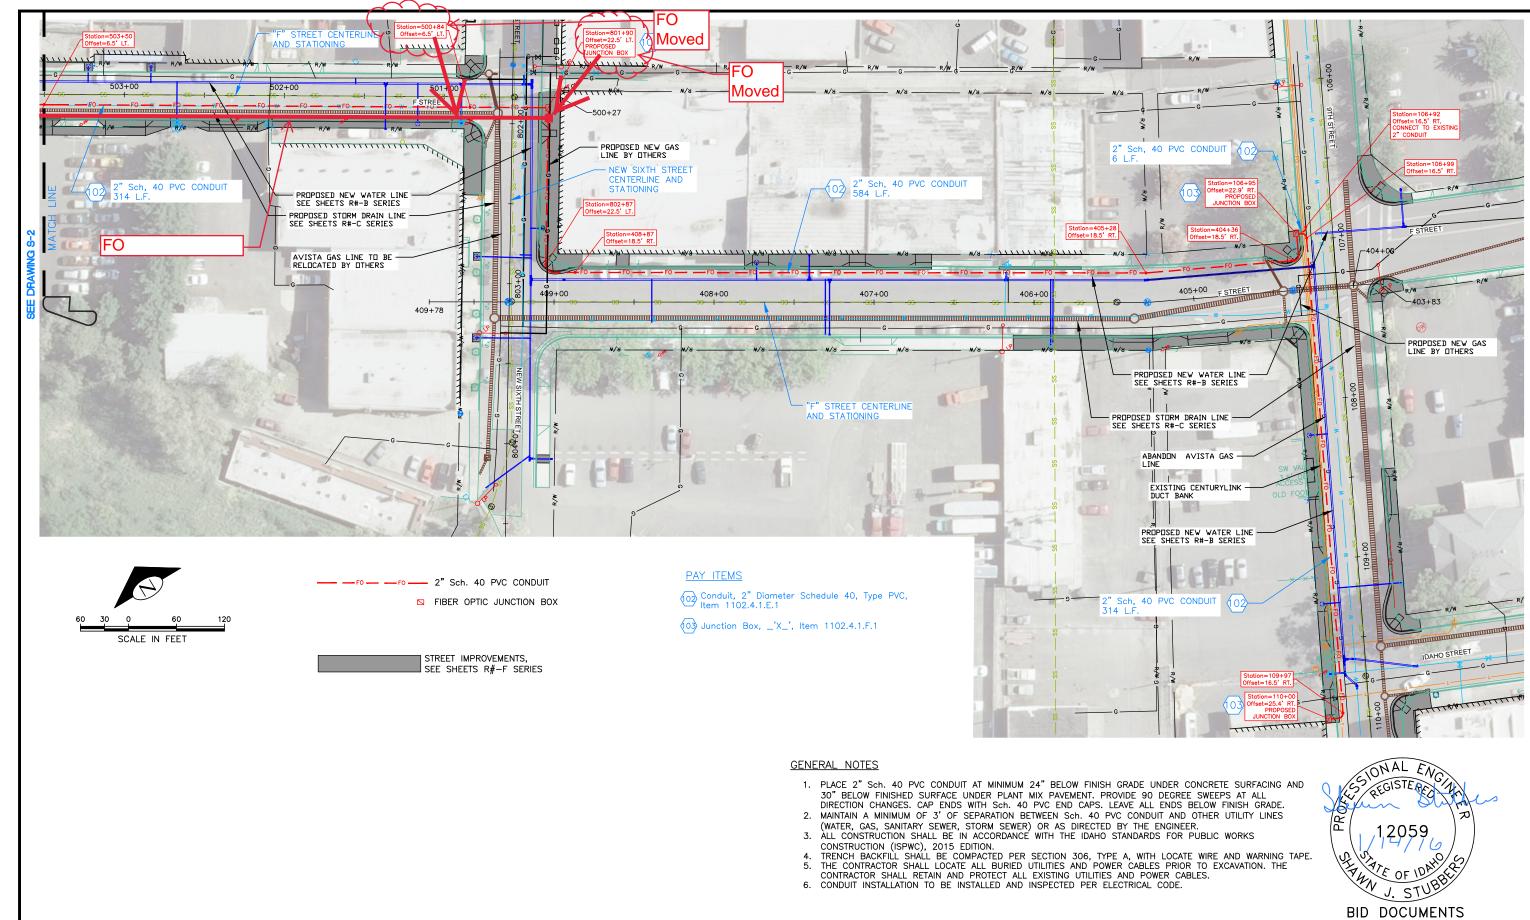


CITY OF LEWISTON
PUBLIC WORKS DEPARTMENT
ENGINEERING SERVICES
215 'D' STREET, LEWISTON, ID 83501
208-746-1316
FAX 208-746-5595




DOWNTOWN INFRASTRUCTURE REPAIR AND REPLACEMENT PROJECT (IRRP-2016)

FRANCHISE UTILITY PLAN

	יטטט טוט	DIVILIALD
DESIGNED BY:	DATE:	PROJECT:
J. KAUFMAN	2015	IRRP-2016
DRAWN BY:	DATE:	SHEET
B. STEWART	12-16-2015	78 _{OF} 89
CHECKED BY:	DATE:	DRAWING: C 1
S. STUBBERS	01-14-2016	2-1

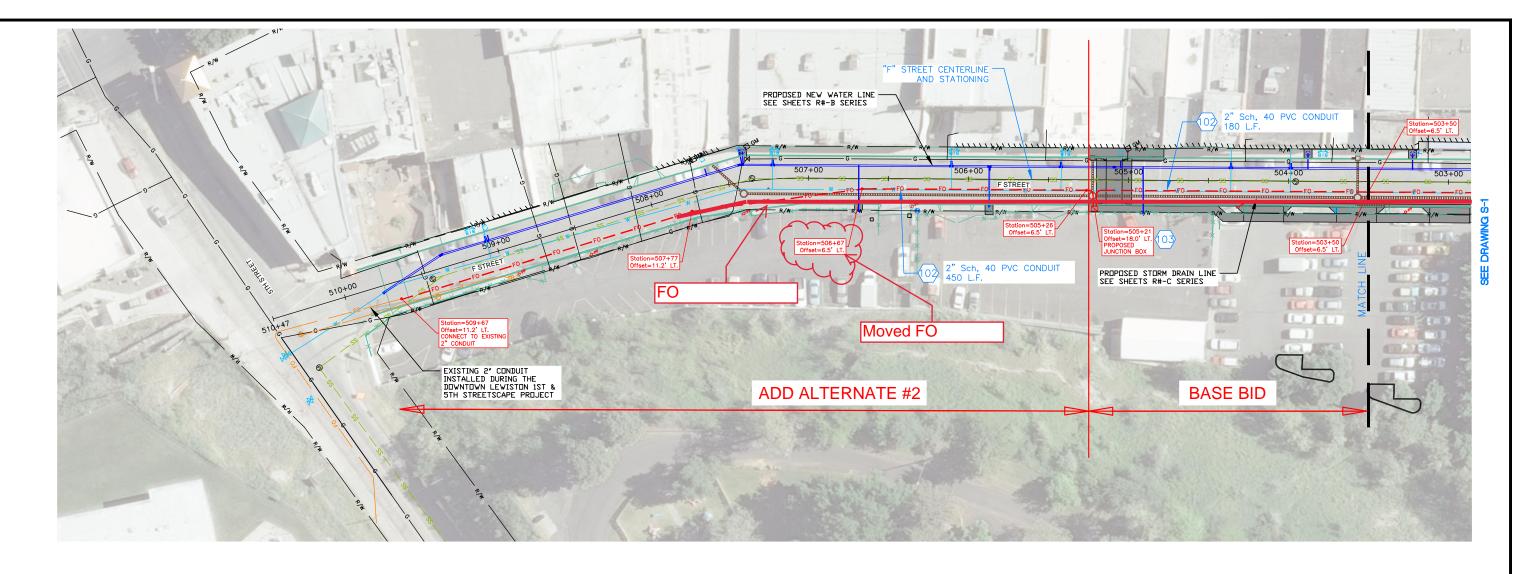

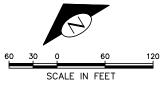

— F0 — F0 — 2" Sch. 40 PVC CONDUIT

□ FIBER OPTIC JUNCTION BOX

STREET IMPROVEMENTS, SEE SHEETS R#-F SERIES

PAY ITEMS

- Conduit, 2" Diameter Schedule 40, Type PVC, Item 1102.4.1.E.1
- 103 Junction Box, _'X_', Item 1102.4.1.F.1

GENERAL NOTES

- 1. PLACE 2" Sch. 40 PVC CONDUIT AT MINIMUM 24" BELOW FINISH GRADE UNDER CONCRETE SURFACING AND PLACE 2" Sch. 40 PVC CONDUIT AT MINIMUM 24" BELOW FINISH GRADE UNDER CONCRETE SURFACING AND 30" BELOW FINISHED SURFACE UNDER PLANT MIX PAVEMENT. PROVIDE 90 DEGREE SWEEPS AT ALL DIRECTION CHANGES. CAP ENDS WITH Sch. 40 PVC END CAPS. LEAVE ALL ENDS BELOW FINISH GRADE.
 MAINTAIN A MINIMUM OF 3' OF SEPARATION BETWEEN Sch. 40 PVC CONDUIT AND OTHER UTILITY LINES (WATER, GAS, SANITARY SEWER, STORM SEWER) OR AS DIRECTED BY THE ENGINEER.
 ALL CONSTRUCTION SHALL BE IN ACCORDANCE WITH THE IDAHO STANDARDS FOR PUBLIC WORKS CONSTRUCTION (ISPWC), 2015 EDITION.
 TRENCH BACKFILL SHALL BE COMPACTED PER SECTION 306, TYPE A, WITH LOCATE WIRE AND WARNING TAPE.
 THE CONTRACTOR SHALL LOCATE ALL BURIED UTILITIES AND POWER CABLES PRIOR TO EXCAVATION. THE CONTRACTOR SHALL RETAIN AND PROTECT ALL EXISTING UTILITIES AND POWER CABLES.
 CONDUIT INSTALLATION TO BE INSTALLED AND INSPECTED PER ELECTRICAL CODE.



BID DOCUMENTS

						14/4 DN IIN I O	
					SCALE	Warning	ı
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					1" = 60'		i
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NO.	DATE	FILENAME	DESCRIPTION	BY	NA	1" ON 22"x34" SHEET	ĺ
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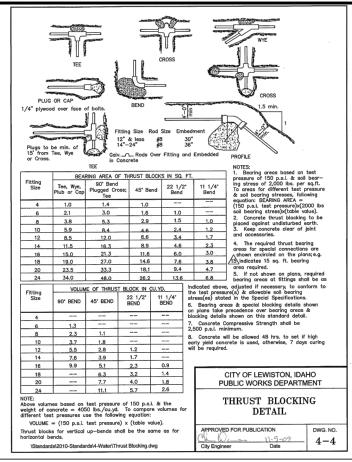
CITY OF LEWISTON PUBLIC WORKS DEPARTMENT ENGINEERING SERVICES
215 'D' STREET, LEWISTON, ID 83501 FAX 208-746-5595





DOWNTOWN INFRASTRUCTURE REPAIR AND REPLACEMENT PROJECT (IRRP-2016)


FRANCHISE UTILITY PLAN


	יססט סום	OWILITIS
DESIGNED BY:	DATE:	PROJECT:
J. KAUFMAN	2015	IRRP-2016
DRAWN BY:	DATE:	SHEET
B. STEWART	12-16-2015	79 _{OF} 89
CHECKED BY:	DATE:	DRAWING: C
S. STUBBERS	01-14-2016	5-2



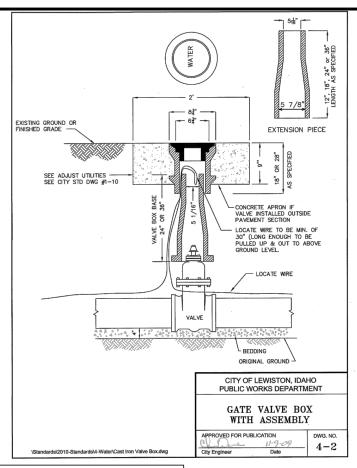

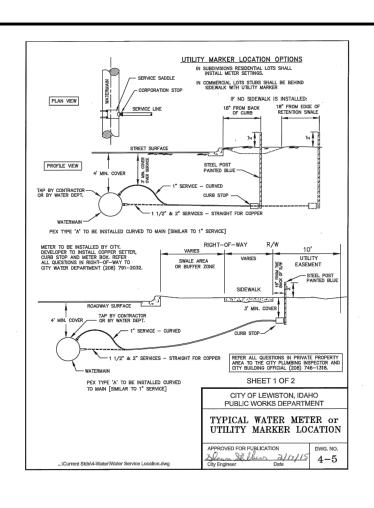

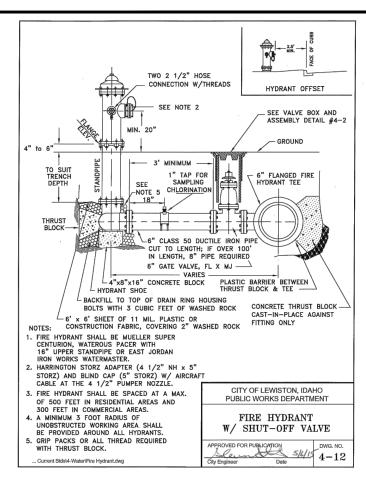

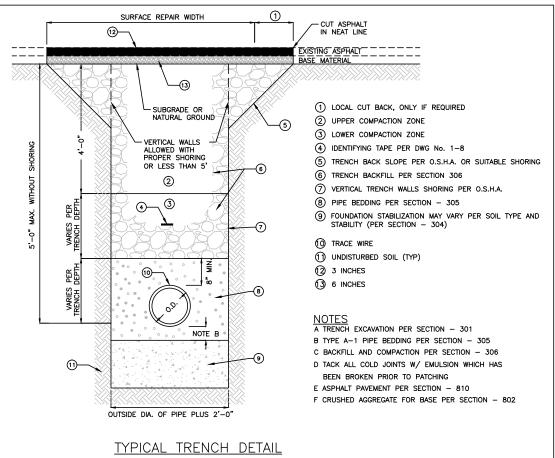

The detail drawings shown hereon are for convenience in bidding and work in the field. Not all the necessary details are shown. A full size copy of all the necessary City of Lewiston Standard Details are provided in the contract documents and may also be found on the City of Lewiston Official Web site http://www.cityoflewiston.org/DocumentCenter under the folder Public Works /Engineering / Standard Dwgs

4 Water Standards

4-1 Potable & Non-potable Waterline Separation November '09
4-2 Gate Valve Box w/ Assembly November '09
4-3 Combination Blow Off & Sampling Tap November '09
4-4 Thrust Blocking Detail November '09
4-5 Typical Water Meter or Utility Marker Location February '15
4-6 ¾ " Water Service Connection
4-7 1 " Water Service Connection February '15
4-8 1 ½ " Water Service Connection February '15
4-9 2 " Water Service Connection February '15
4-10 Double Check Valve Assembly for 2 " or Smaller February '15
4-11 Double Check Valve Assembly for 2 1/2" or Larger February '15
4-12 Fire Hydrant w/ Shut-off Valve May '15

BID DOCUMENTS

SCALE
HORIZONTAL
AS SHOWN
THIS BAR MEASURES
NO. DATE FILENAME DESCRIPTION
REVISIONS

SCALE
HORIZONTAL
AS SHOWN
VERTICAL
1/2" ON 11"x17" SHEET
NA 1" ON 22"x34" SHEET
WHEN PLOTTED TO SCAL


CITY OF LEWISTON
PUBLIC WORKS DEPARTMENT
ENGINEERING SERVICES
215 'D' STREET, LEWISTON, ID 83501
208-746-1316
FAX 208-746-5595





DOWNTOWN INFRASTRUCTURE REPAIR AND REPLACEMENT PROJECT (IRRP-2016)


DETAILS WATER


1	DESIGNED BY:	DATE:	PROJECT:			
	J. KAUFMAN	2015	IRF	RP-	-201	6
	DRAWN BY: B. STEWART	DATE: 12-16-2015	SHEET 80	0	OF	89
	CHECKED BY: S. STUBBERS	DATE: 01-14-2016	DRAWING:		B-	1

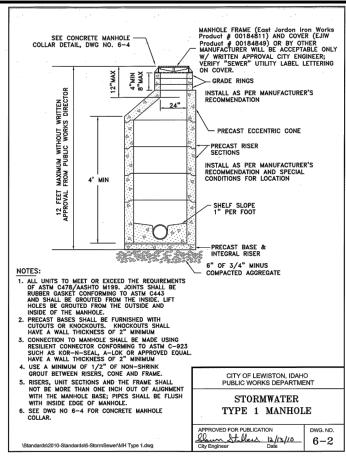


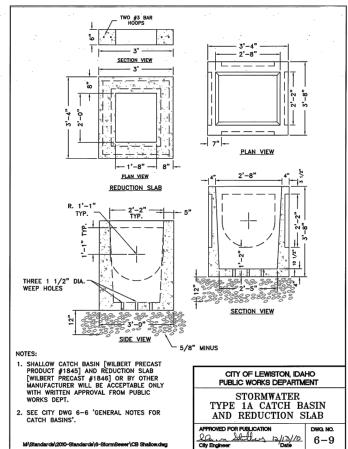

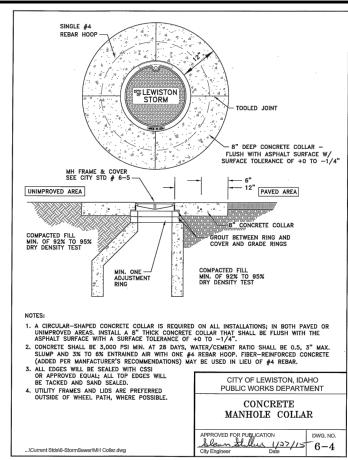

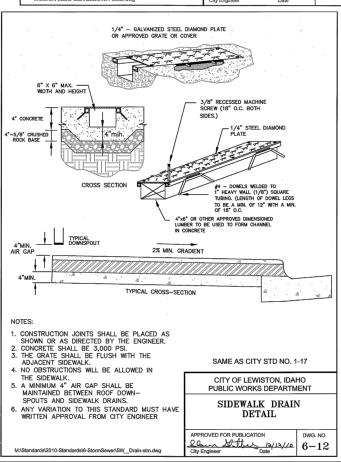

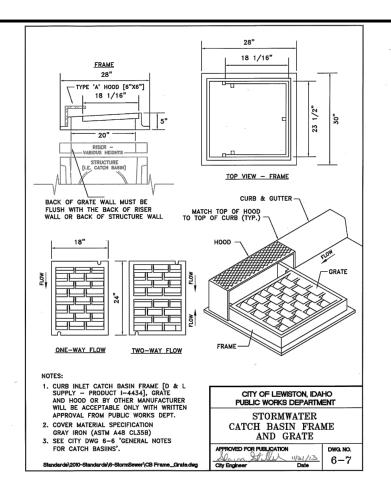

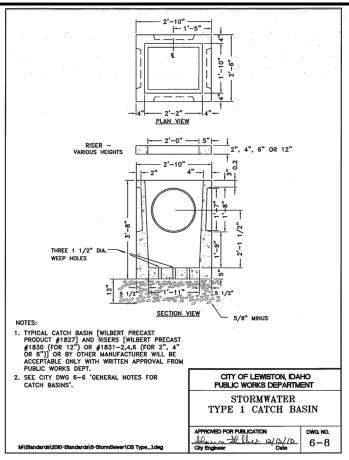

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6 Stormwater Standards

6-1 System General Notes	
6-3 Type 1A (Shallow) Manhole	
6-4 Manhole Concrete Collar January	
6-5 Manhole Frame and Cover	'10
6-6 General Catch Basin Notes	r '10
6-7 Catch Basin Frame and Grate Novembe	r '13
6-8 Type 1 Catch Basin	· '10
6-9 Type 1A (Shallow) Catch Basin and Reduction Slab December	'10
6-10 Standard Curb Drop Inlet	r '10
6-11 Special Curb Inlet Type '2" December	r '10
6-12 Sidewalk Drain Detail	r '10

BID DOCUMENTS

SCALE
HORIZONTAL
AS SHOWN
VERTICAL
NO. DATE FILENAME
DESCRIPTION
BY
NA

WARNING

0 1/2 1

THIS BAR MEASURES
1/2" ON 11"x17" SHEET


CITY OF LEWISTON
PUBLIC WORKS DEPARTMENT
ENGINEERING SERVICES
215 'D' STREET, LEWISTON, ID 83501
208-746-1316
FAX 208-746-5595





DOWNTOWN INFRASTRUCTURE REPAIR
AND REPLACEMENT PROJECT (IRRP-2016)


DETAILS STORM

DESIGNED BY:	DATE:	PROJECT:	
S. MACEY	2015	IRRP-2016	
DRAWN BY:	DATE:	SHEET	
B. STEWART	12-16-2015	81 _{OF} 89	
CHECKED BY:	DATE:	DRAWING: 0	
S. STUBBERS	01-14-2016	C-1	

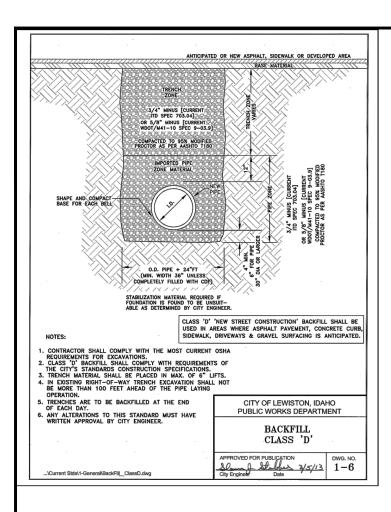

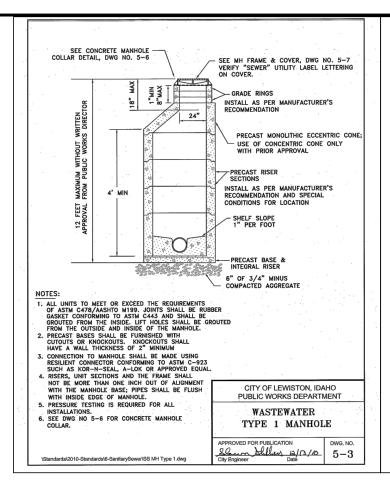

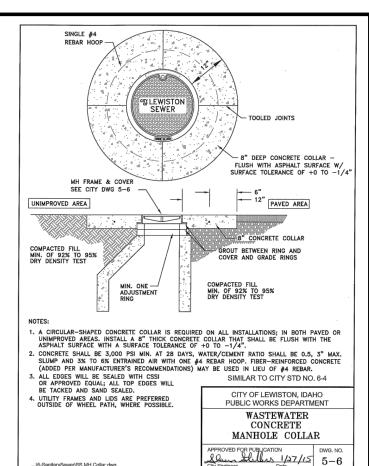

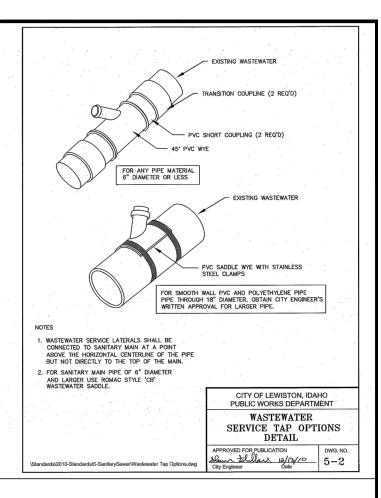

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5 Wastewater Standards

5-1 Wastewater Private Service Connection	December '10
5-2 Service Tap Options	December '10
5-3 Type 1 Manhole Details	December '10
5-4 Type 1A Manhole (Shallow MH)	November '15
5-5 Pressure Wastewater System Service Connection	December '10
5-6 Concrete Manhole Collar	January '15
5-7 Manhole Frame & Cover	November '12
5-8 Manhole Channel Details	September '15

BID DOCUMENTS

SCALE

HORIZONTAL

AS SHOWN

NO. DATE FILENAME DESCRIPTION BY

REVISIONS

SCALE

HORIZONTAL

AS SHOWN

VERTICAL

NA

WARNING

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THIS BAR MEASURES
1/2" ON 11"x17" SHEET
1" ON 22"x34" SHEET
WHEN PLOTTED TO SCALE


CITY OF LEWISTON
PUBLIC WORKS DEPARTMENT
ENGINEERING SERVICES
215 'D' STREET, LEWISTON, ID 83501
208-746-1316
FAX 208-746-5595





DOWNTOWN	INFRA	STRUCTU	RE	REPAIR	
AND REPLACE	MENT	PROJECT	(IF	RRP-201	6)


DETAILS SANITARY


DESIGNED BY:	DATE:	PROJECT:		
J. KAUFMAN	2015	IRRP-2016		
DRAWN BY:	DATE:	SHEET		
B. STEWART	12-16-2015	82	OF	89
CHECKED BY:	DATE:	DRAWING:	_	4
S. STUBBERS	01-14-2016		上一	1

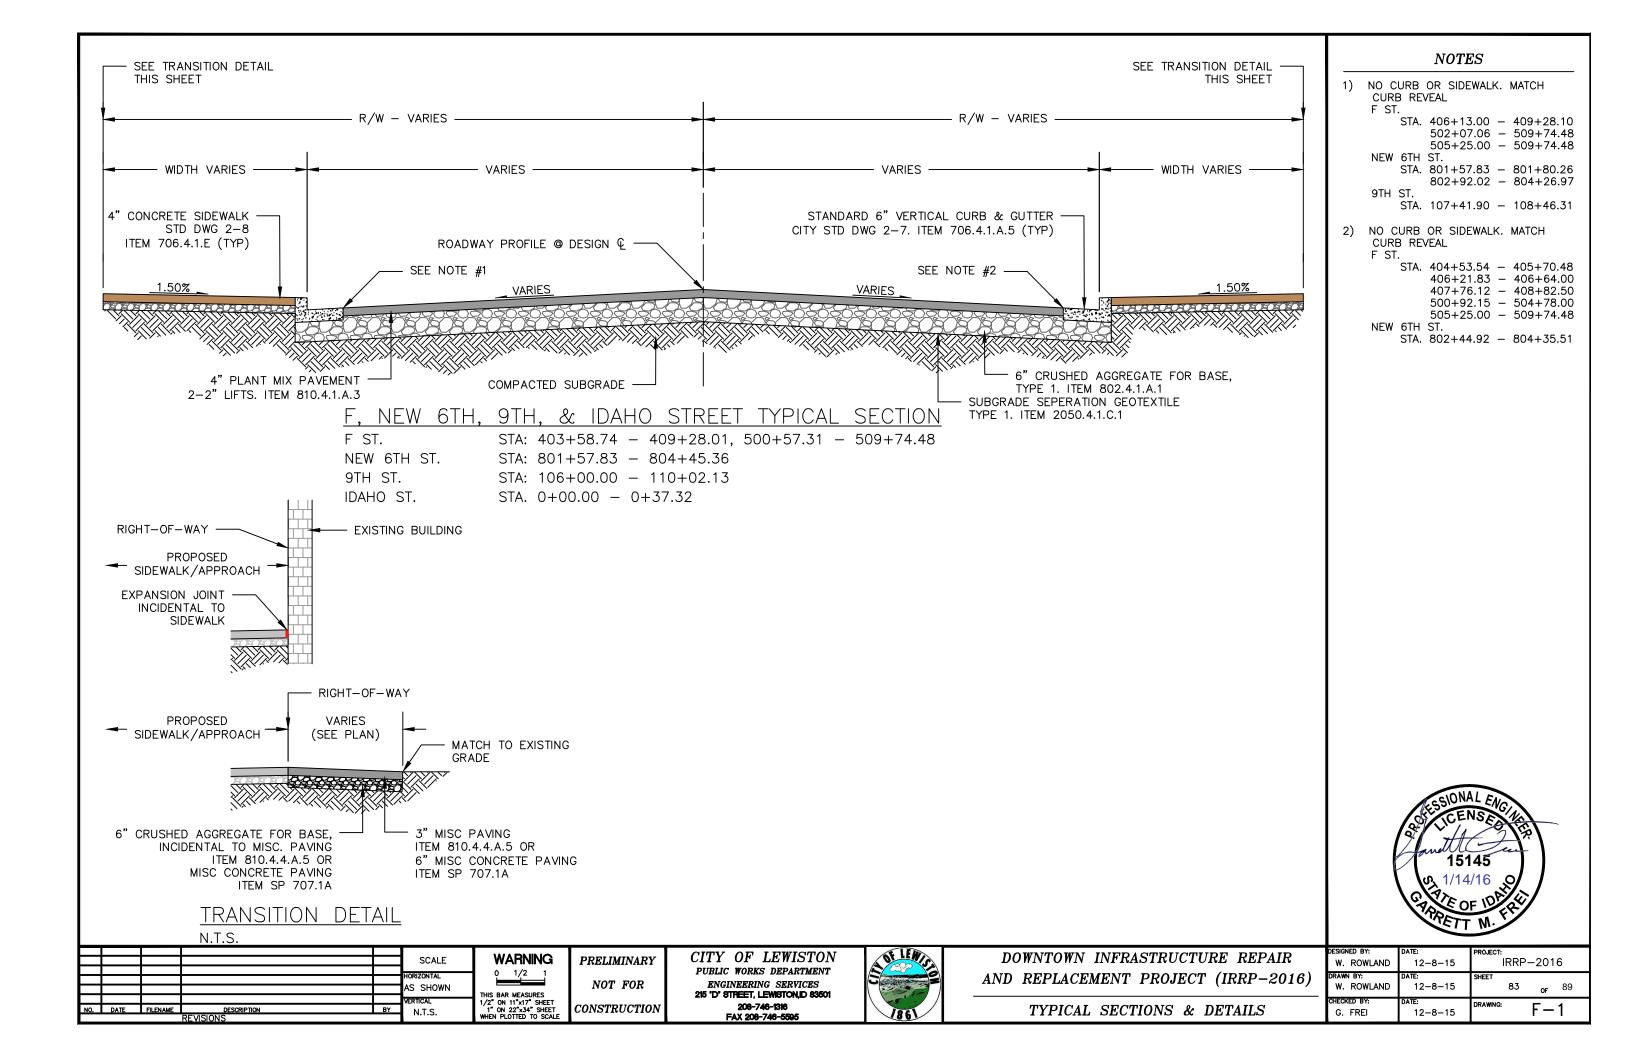

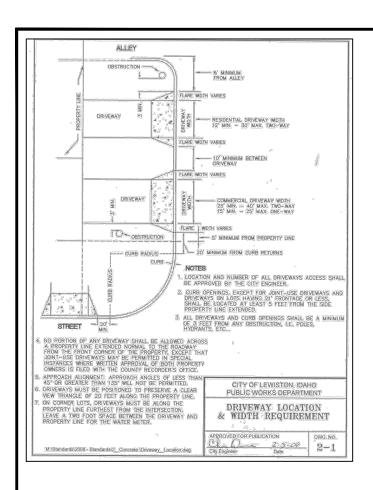


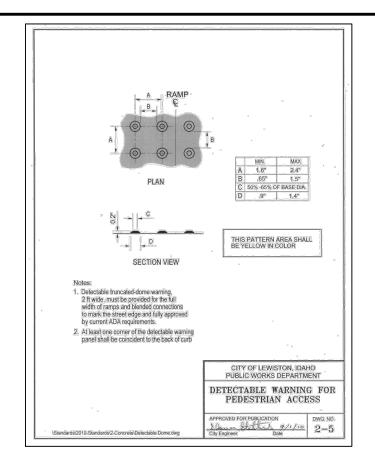

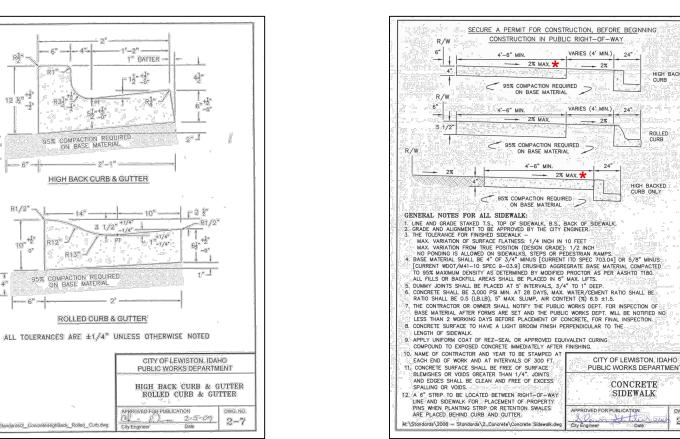

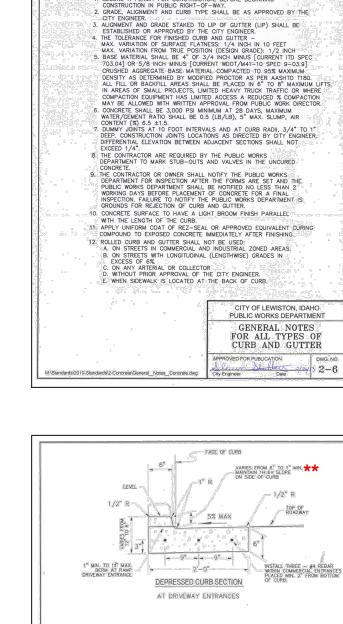


GENERAL NOTES FOR ALL TYPES OF CURB AND GUTTER SECURE A PERMIT FOR CONSTRUCTION, BEFORE BEGINNING
 CONSTRUCTION IN PUBLIC RIGHT-OF-WAY,
 GRADE, ALIGNMENT AND CURB TYPE SHALL BE AS APPROVED BY THE
CITY ENGINEER.

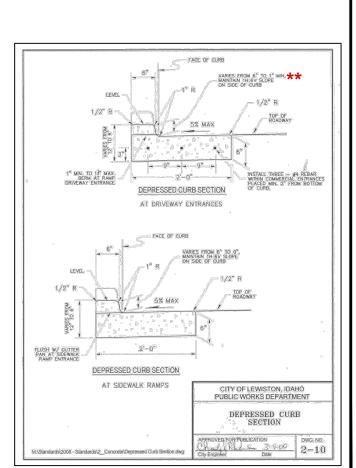



SIDEWALK TO BE CONSTRUCTED WITH A 1.5% SLOPE

CURB HEIGHT TO BE 2.4" ON DRIVEWAY APPROACHES THAT ARE 3' IN DEPTH.

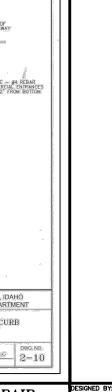

_					
					SCALE
					HORIZONTAL AS SHOWN
					VERTICAL
NO.	DATE	FILENAME	DESCRIPTION REVISIONS	BY	N.T.S.

WARNING 1/2 1 THIS BAR MEASURES

PRELIMINARY NOT FOR CONSTRUCTION CITY OF LEWISTON PUBLIC WORKS DEPARTMENT ENGINEERING SERVICES 215 'D' STREET, LEWISTONID 83501 FAX 208-746-5595


HIGH BACKED CURB




DOWNTOWN INFRASTRUCTURE REPAIR AND REPLACEMENT PROJECT (IRRP-2016)


TYPICAL SECTIONS & DETAILS


DESIGNED BY:	DATE:	PROJECT:
W. ROWLAND	12-8-15	IRRP-2016
DRAWN BY:	DATE:	SHEET
W. ROWLAND	12-8-15	84 _{OF} 89
CHECKED BY:	DATE:	DRAWING:
G. FREI	12-8-15	F - 2

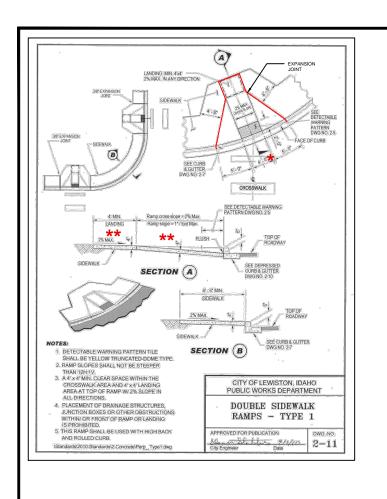

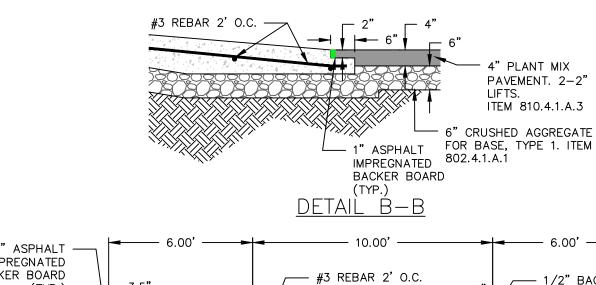

1" ASPHALT **IMPREGNATED** BACKER BOARD 1/2" BACKER - 3.5**"** (TYP.) BOARD BELOW #3 REBAR 2' O.C. SEE DETAIL B-B FG (TYP.) 4" PLANT MIX PAVEMENT. 2-2" 3.50' -COMPACTED SUBGRADE LIFTS. 6" CRUSHED AGGREGATE FOR BASE, SUBGRADE SEPERATION GEOTEXTILE ITEM 810.4.1.A.3 TYPE 1. ITEM 802.4.1.A.1 TYPE 1. ITEM 2050.4.1.C.1 6" CONCRETE @ 4000 PSI MIN. SECTION A-A

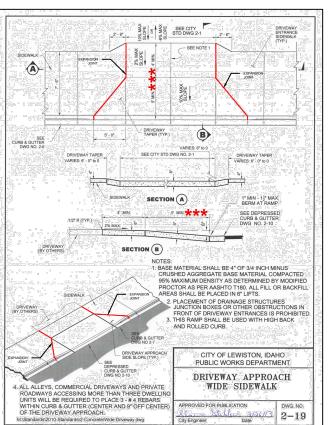

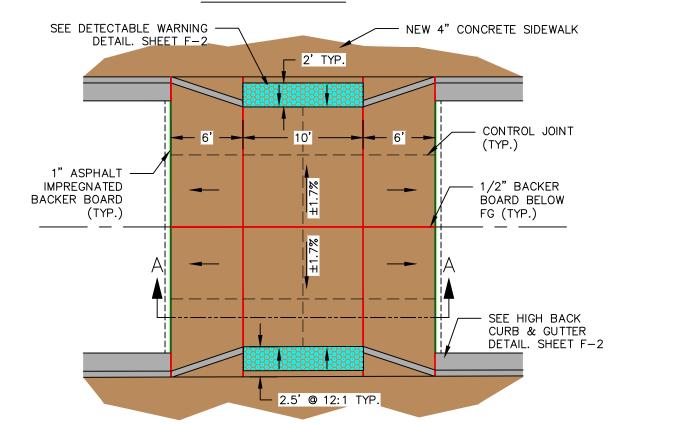

RAISED CROSSWALK DETAIL N.T.S.

					SCALE	
					HORIZONTAL AS SHOWN	
NO.	DATE	FILENAME	DESCRIPTION	BY	VERTICAL	17
	REVISIONS				N.T.S.	W

WARNING

0 1/2 1

THIS BAR MEASURES
1/2" ON 11"x17" SHEET
1" ON 22"x34" SHEET
WHEN PLOTTED TO SCALE

PRELIMINARY

NOT FOR

CONSTRUCTION

CITY OF LEWISTON
PUBLIC WORKS DEPARTMENT
ENGINEERING SERVICES
215 'D' STREET, LEWISTON,D 83501
208-746-1316
FAX 208-746-5595



DOWNTOWN INFRASTRUCTURE REPAIR AND REPLACEMENT PROJECT (IRRP-2016)

TYPICAL SECTIONS & DETAILS

NOTES

TYPE I PEDESTRIAN RAMPS TO BE CONSTRUCTED AT A WIDTH OF 4'-0"

**

ALL RAMPS TO BE CONSTRUCTED AT A DEPTH OF 6", EXCEPT FOR THE RAMPS LOCATED AT:
F ST.

STA. 403+83.25 (RT.) 404+33.93 (LT.)


NEW 6TH ST. STA. 802+05.49

STA. 802+05.49 (LT.) 802+05.57 (RT.)


**


RAMPS WILL BE CONSTRUCTED WITH A DEPTH OF 3'-0", EXCEPT FOR RAMPS LOCATED AT:

F ST. STA. 502+99.12 503+57.28 504+15.36

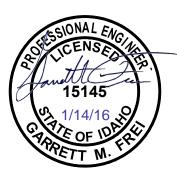


DESIGNED BY: W. ROWLAND	DATE: 12-8-15	PROJECT: IRRP-2016
DRAWN BY: W. ROWLAND	DATE: 12-8-15	85 of 89
CHECKED BY: G. FREI	DATE: 12-8-15	DRAWING: F-3

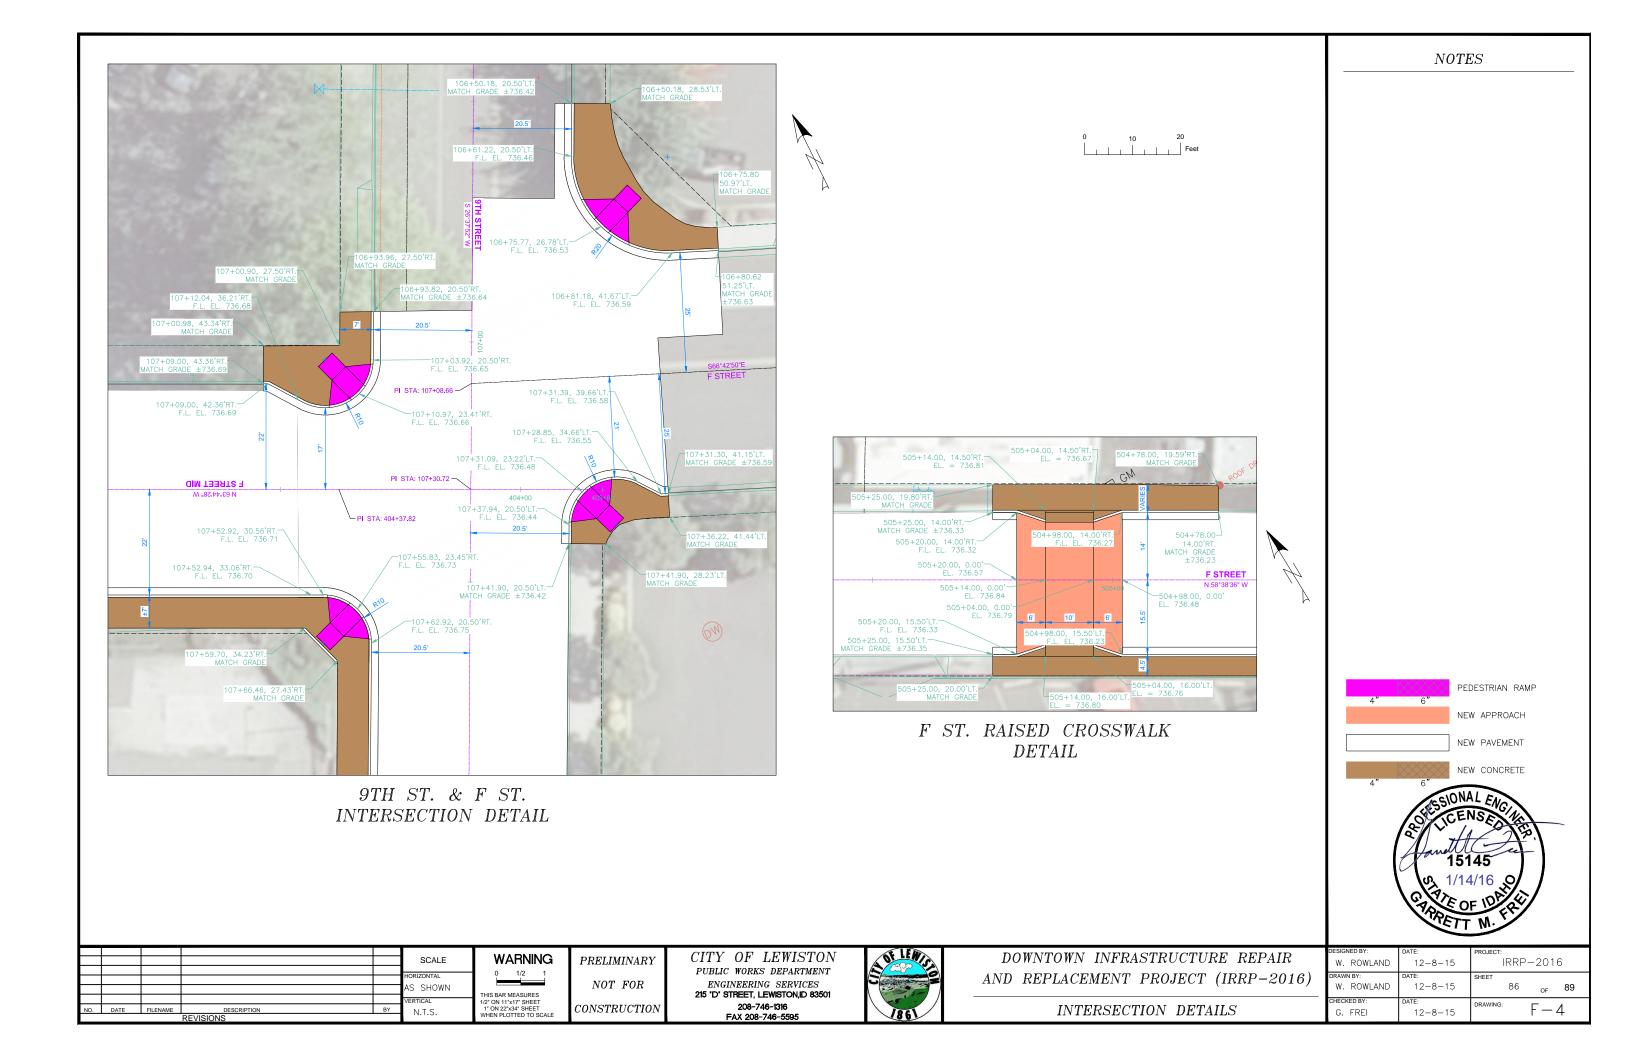

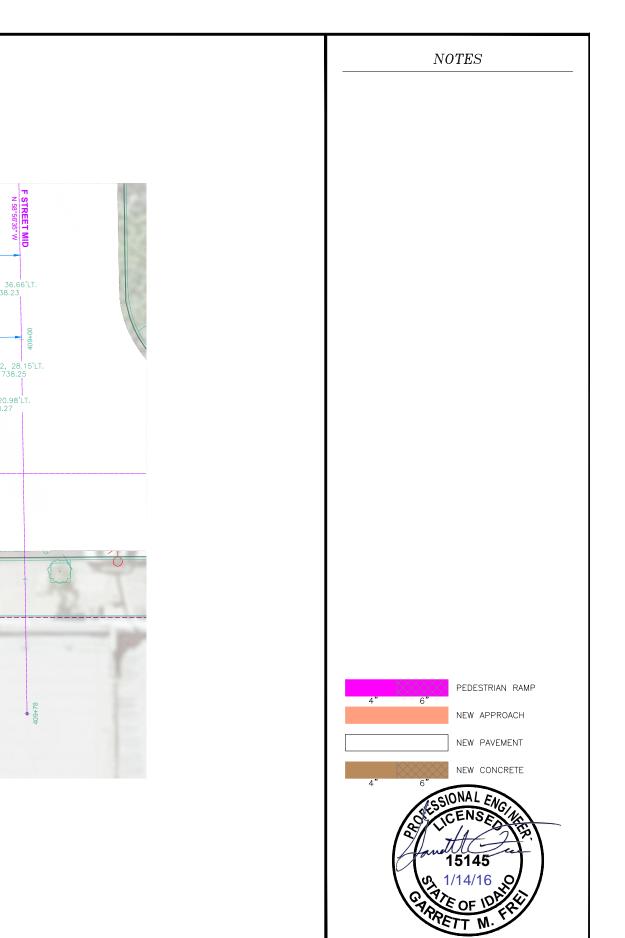



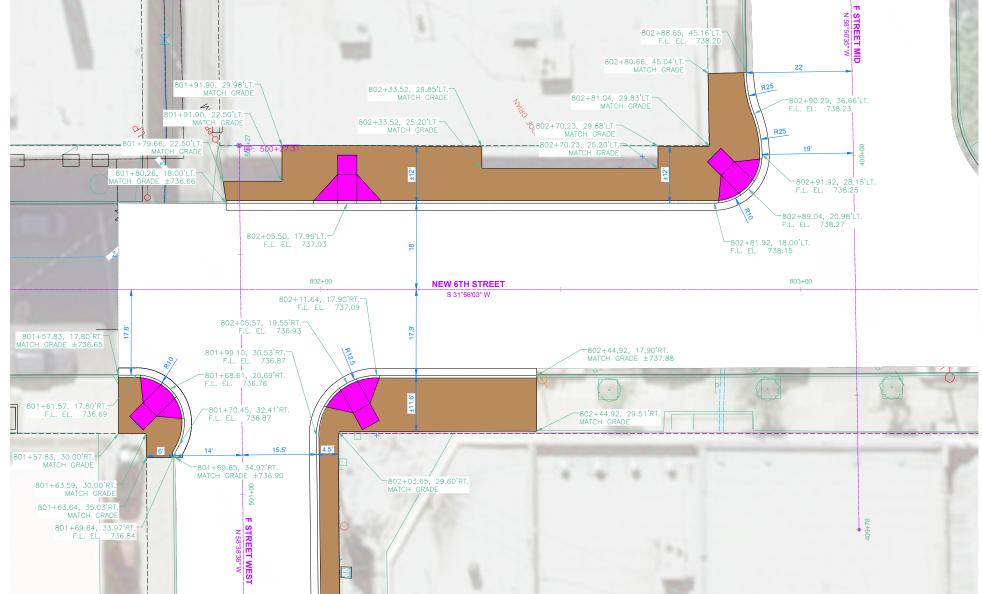

NEW 6TH ST. & F ST. INTERSECTION DETAIL

					SCALE	WA
					HORIZONTAL AS SHOWN	0
NO.	DATE	FILENAME	DESCRIPTION	BY	VERTICAL N.T.S.	THIS BAR M 1/2" ON 11"x 1" ON 22"x:
	REVISIONS				14.1.5. WHE	WHEN PLOT

WARNING

O 1/2 1

BAR MEASURES IN 11'11' SHEET IN 22'34' SHEET IN PLOTTED TO SCALE

PRELIMINARY

NOT FOR

CONSTRUCTION

CITY OF LEWISTON

PUBLIC WORKS DEPARTMENT

ENGINEERING SERVICES
215 'D' STREET, LEWISTON,ID 83501

208-746-1316

FAX 208-746-5595



DOWNTOWN INFRASTRUCTURE REPAIR AND REPLACEMENT PROJECT (IRRP-2016)

INTERSECTION .	DETAILS
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	DESIGNED BY:	DATE:	PROJECT:
	W. ROWLAND	12-8-15	IRRP-2016
ı	DRAWN BY:	DATE:	SHEET
	W. ROWLAND	12-8-15	87 _{of} 89
ı	CHECKED BY:	DATE:	DRAWING:
	G. FREI	12-8-15	F-5

